


- SYNERGY 85S CONTROLLER CLOSET
- ELEVATOR EV04 CONTROLLER EQUIPMENT
- (2) 2'-6" x 6'-8" 90 MIN. RATED DOORS
- 6" FLOOR DRAIN WITH SQUARE STRAINER.
- TA-11
- FLOOR MOUNTED TOILET W/ FLUSH SENSOR. REFER TO PLUMBING DRAWINGS
- TA-02

MOORE SCHOOL OF BUSINESS
 UNIVERSITY OF SOUTH CAROLINA
 BID PACKAGE 3
 ENCLOSURE/SITE/MEPFP/INTERIOR
 ADDENDUM #003
 PROJECT NO. 655.000

2012.06.22
 RAFAEL VINOLY ARCHITECTS PC

ENLARGED PLAN - ELEVATOR EV4 CONTROL CLOSET AT LEVEL 0 AUDITORIUM
 REF. DWG # 07/A5000, A1100, A1100F
 SHEET TITLE :

SCALE :
 1/4" = 1'-0"
 SHEET NUMBER :
 A-SK-063

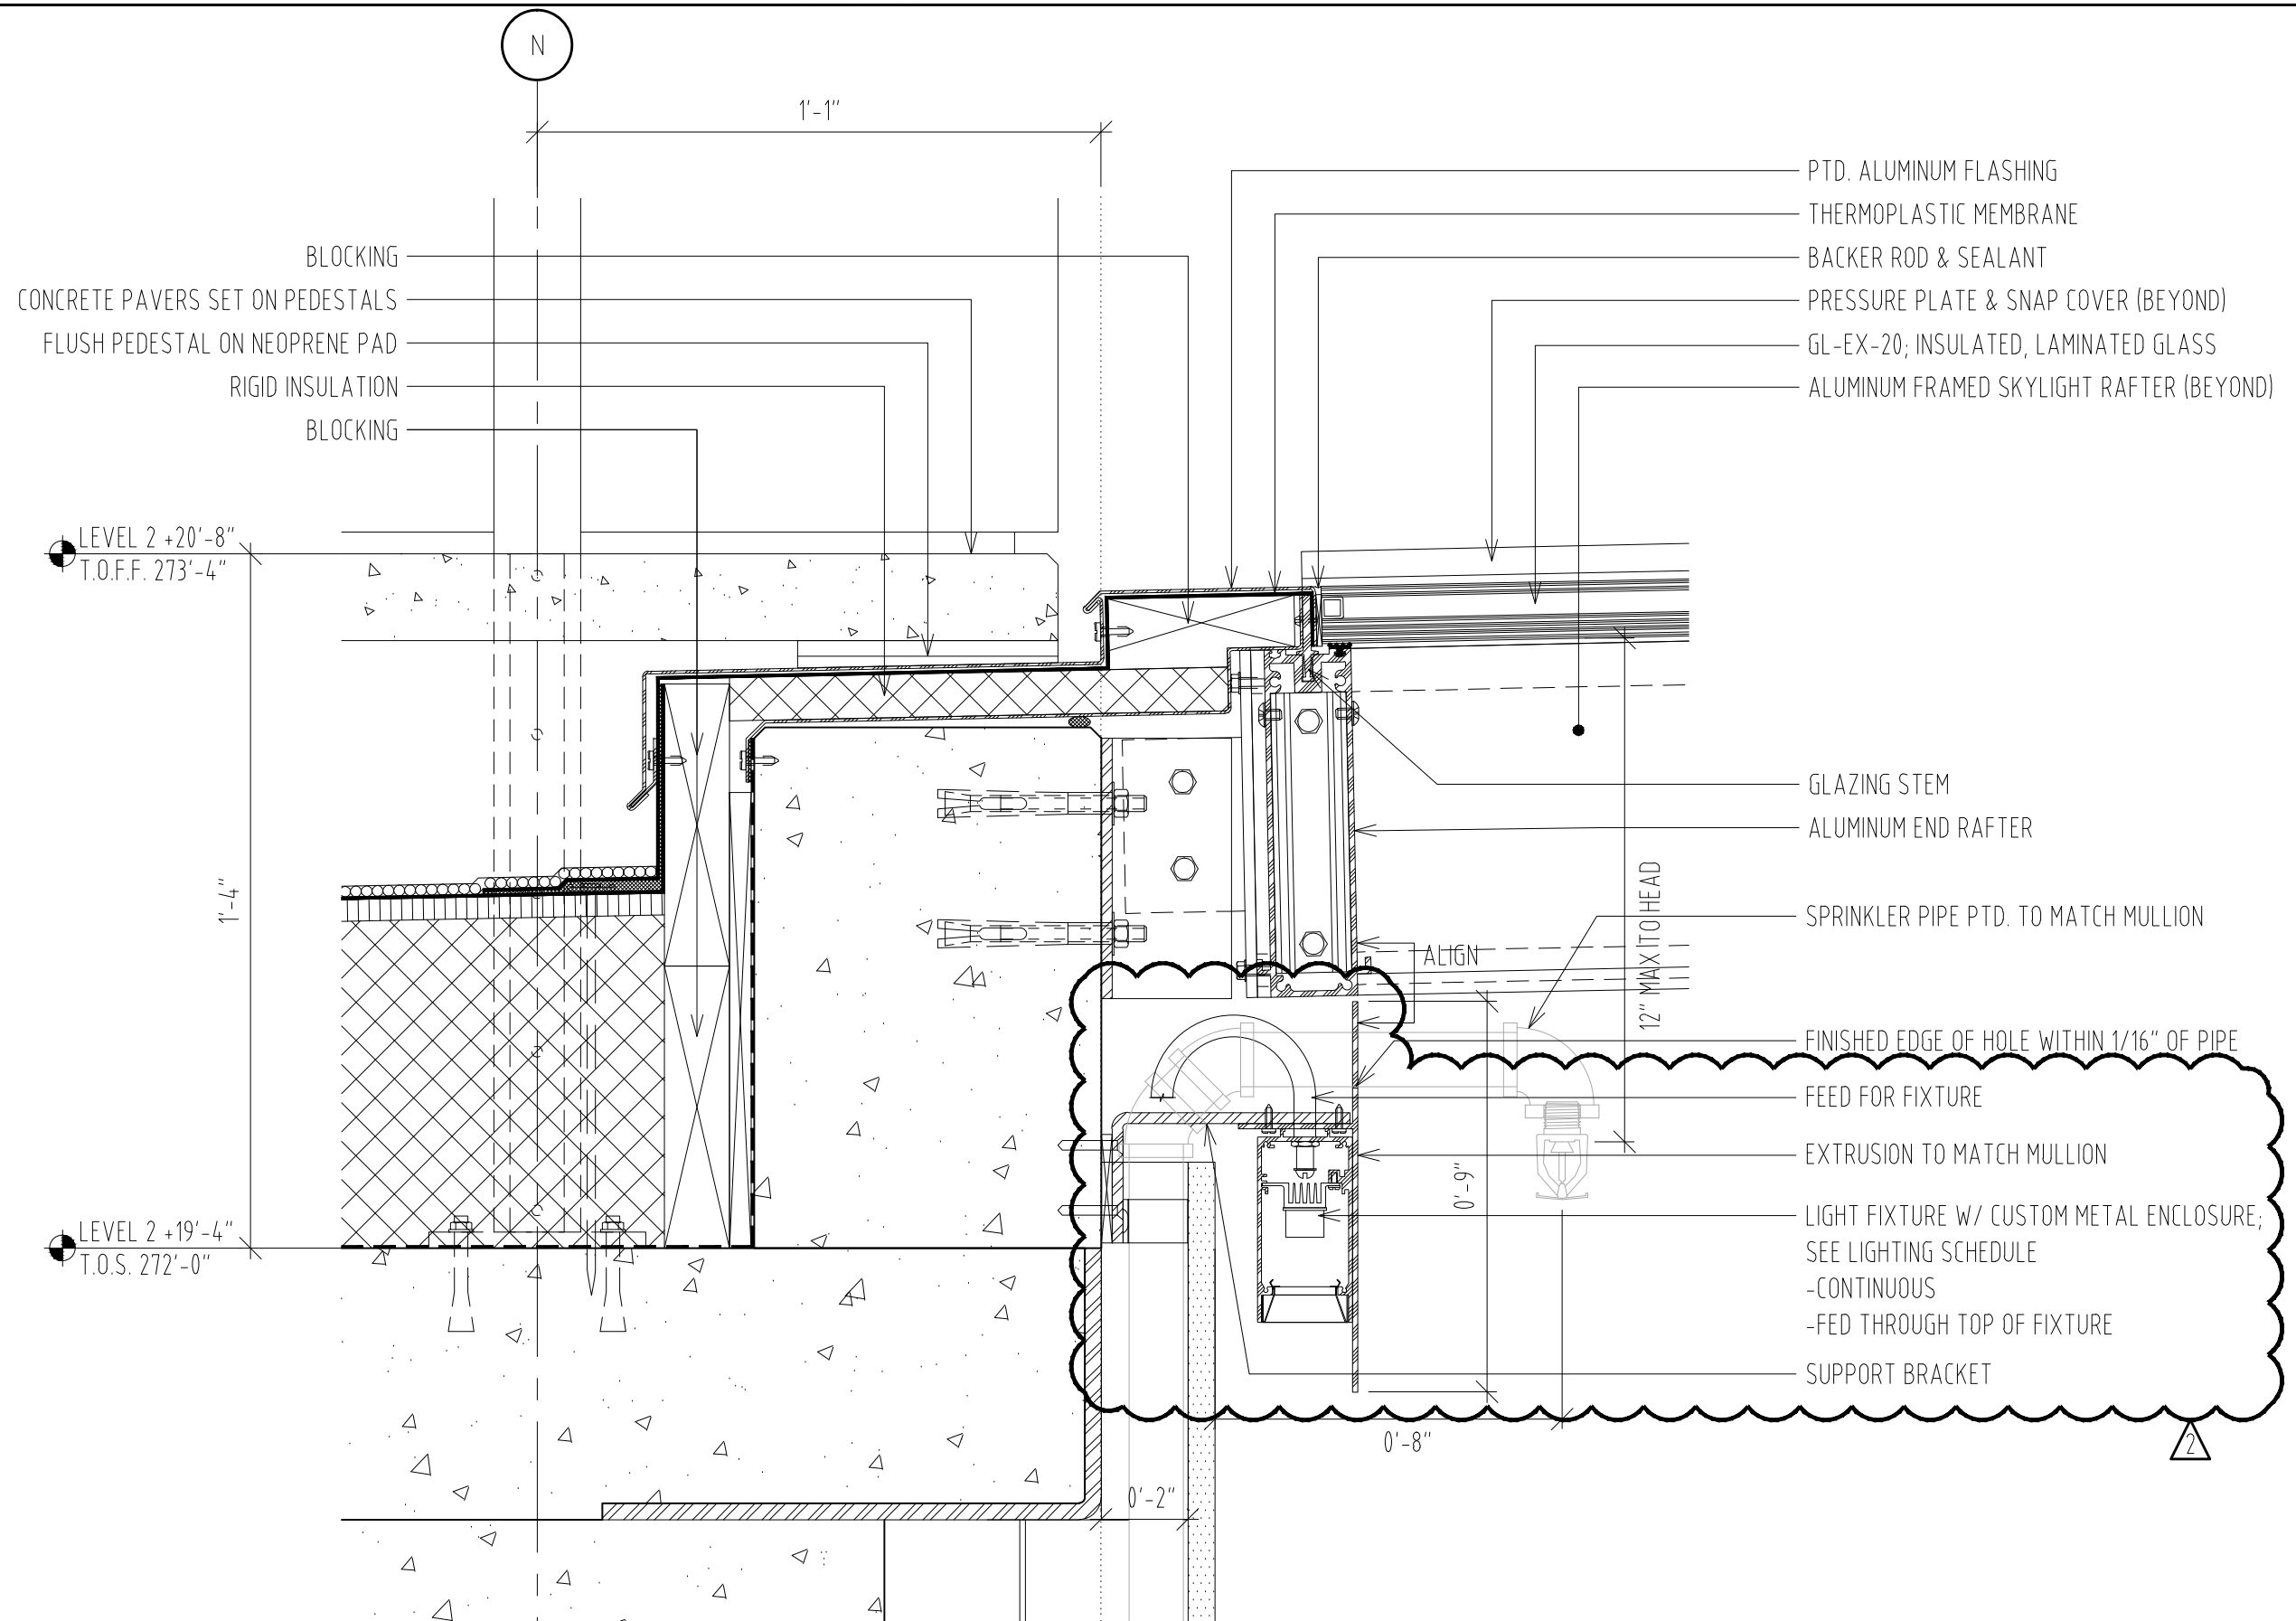

MOORE SCHOOL OF BUSINESS
 UNIVERSITY OF SOUTH CAROLINA
 BID PACKAGE 3
 ENCLOSURE/SITE/MEPFP/INTERIOR
 ADDENDUM #003

PROJECT NO. 655.000


^ ^
 2012.06.22
 © RAFAEL VINOLY ARCHITECTS PC

TYPICAL DETAIL SECTION AT LEVEL 2 SKYLIGHT
 REF. DWG # 01/A4912


SHEET TITLE :

SCALE :
 3" = 1'-0"

SHEET NUMBER :
 A-SK-064

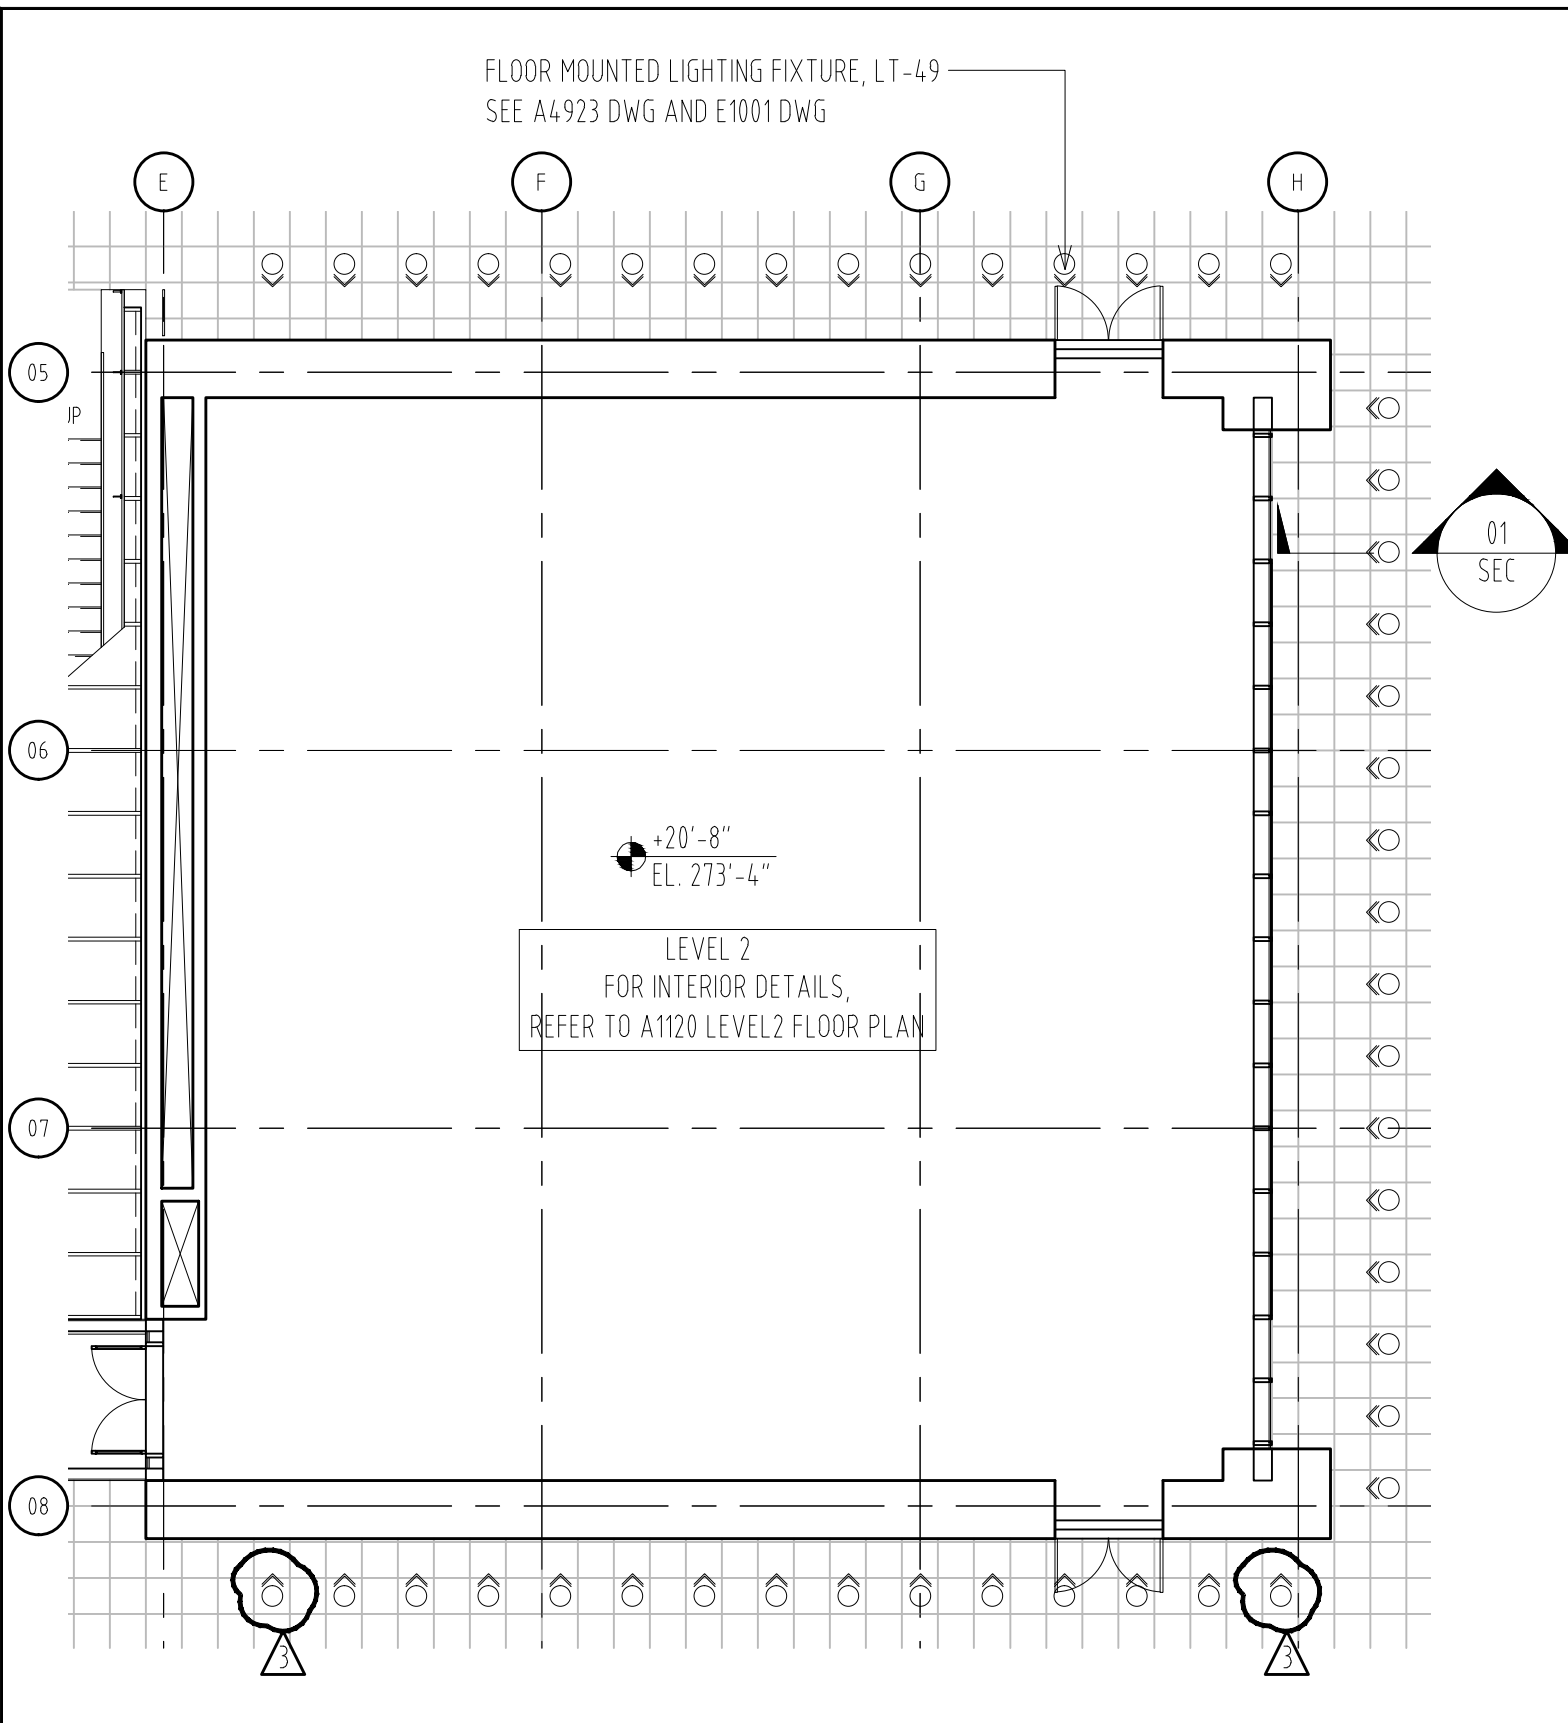

ENLARGED PLAN - LEVEL 2
SCALE 3/32" = 1'-0" 02

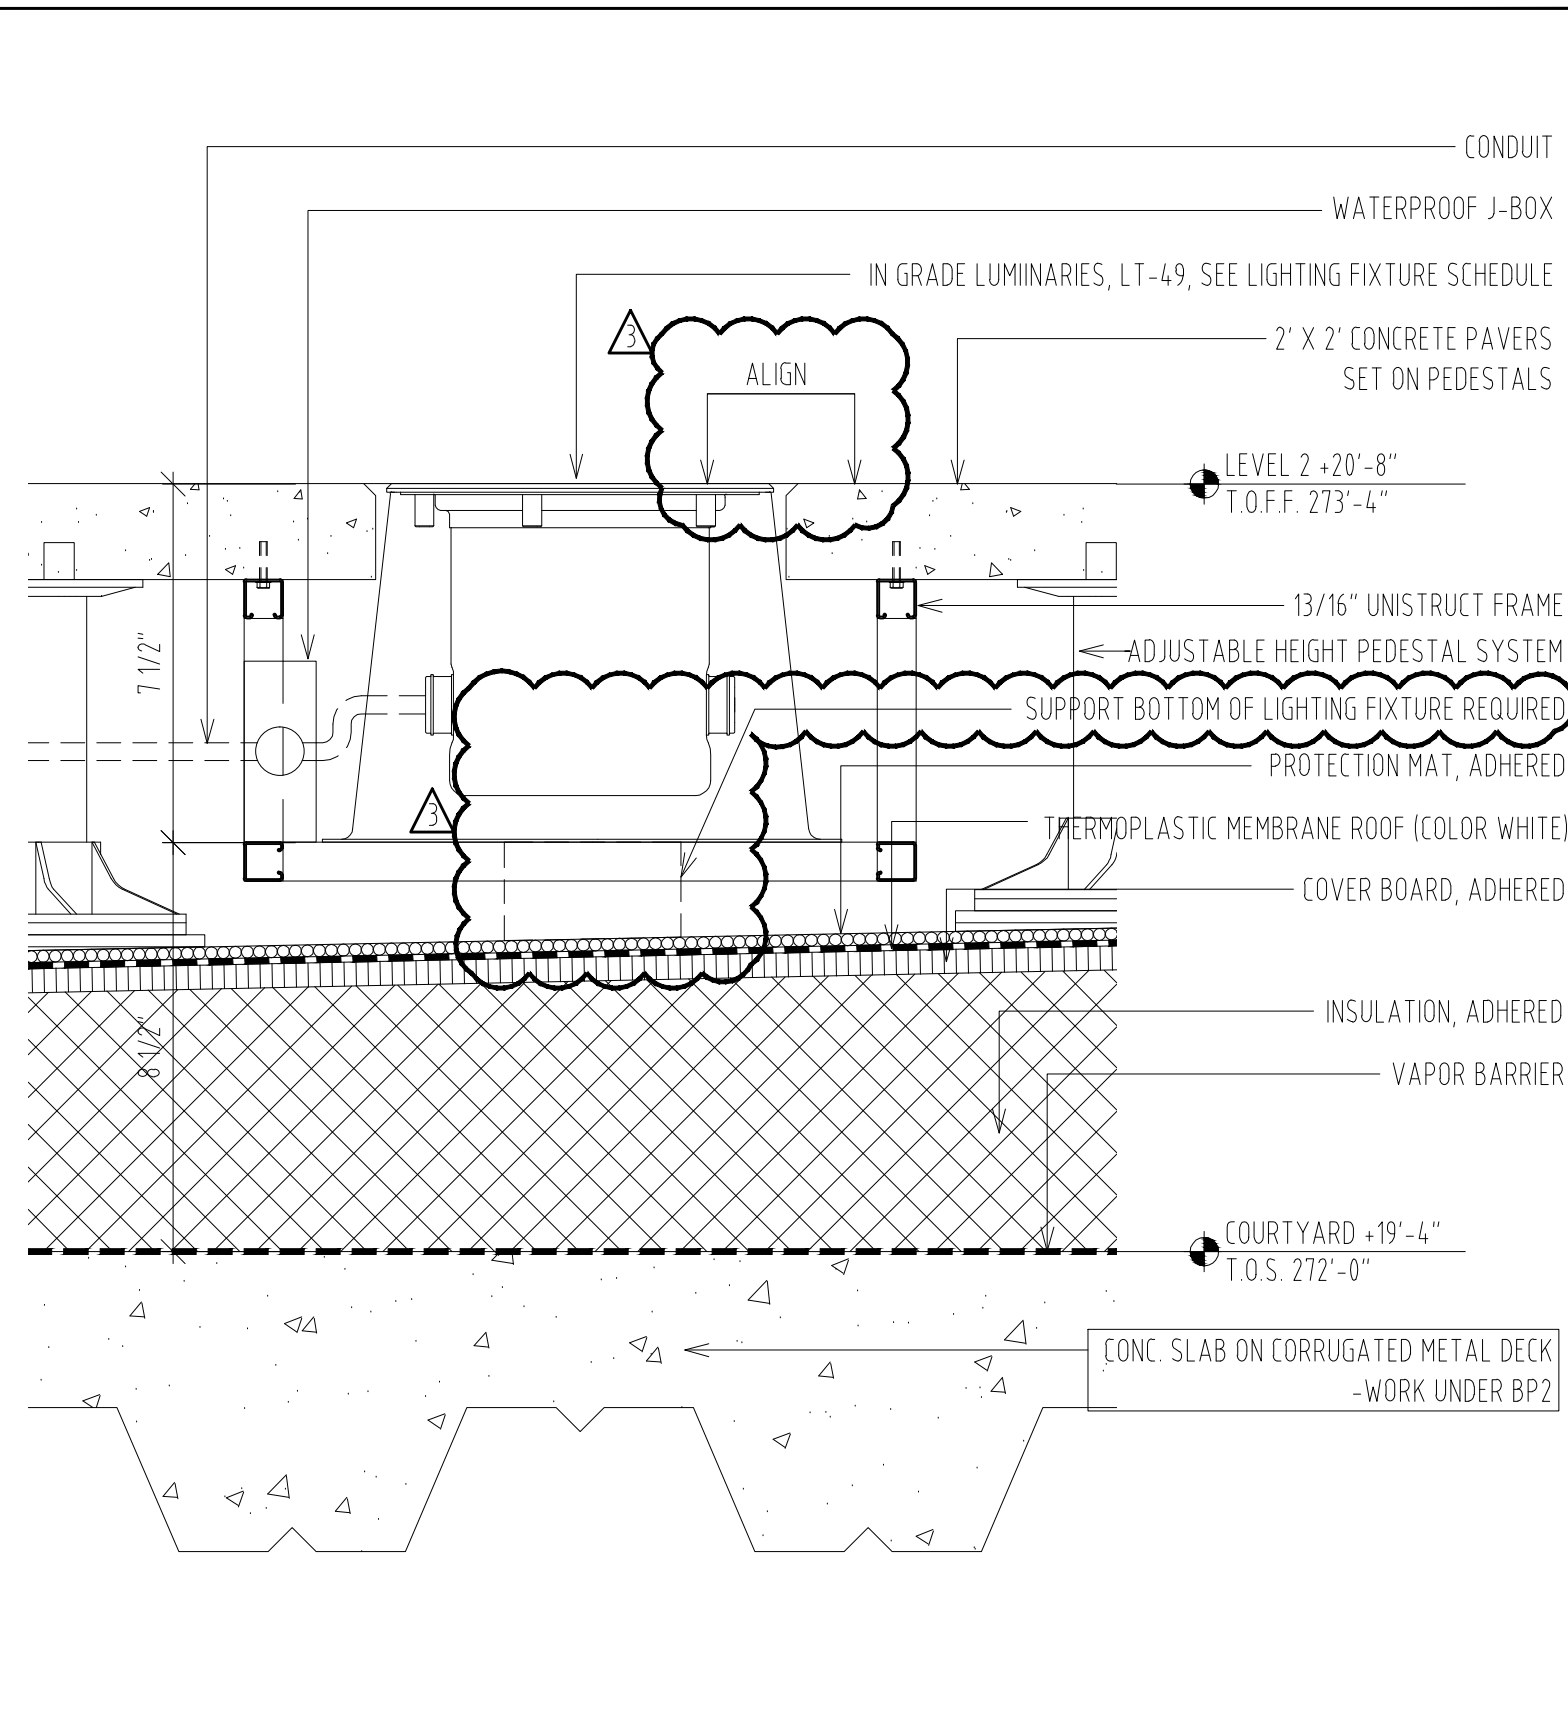


FLOOR MOUNTED LIGHTING FIXTURE (LT-49) SECTION AT LEVEL 2
SCALE 3" = 1'-0" 01

MOORE SCHOOL OF BUSINESS
UNIVERSITY OF SOUTH CAROLINA
BID PACKAGE 3
ENCLOSURE/SITE/MEPFP/INTERIOR
ADDENDUM #003
PROJECT NO. 655.000


2012.06.22
© RAFAEL VINOLY ARCHITECTS PC

EXTERIOR FLOOR LIGHTING FIXTURE AT LEVEL 2
REF. DWG # A0303, A1120, A4923
SHEET TITLE :

SCALE :
VARIES
SHEET NUMBER :
A-SK-065

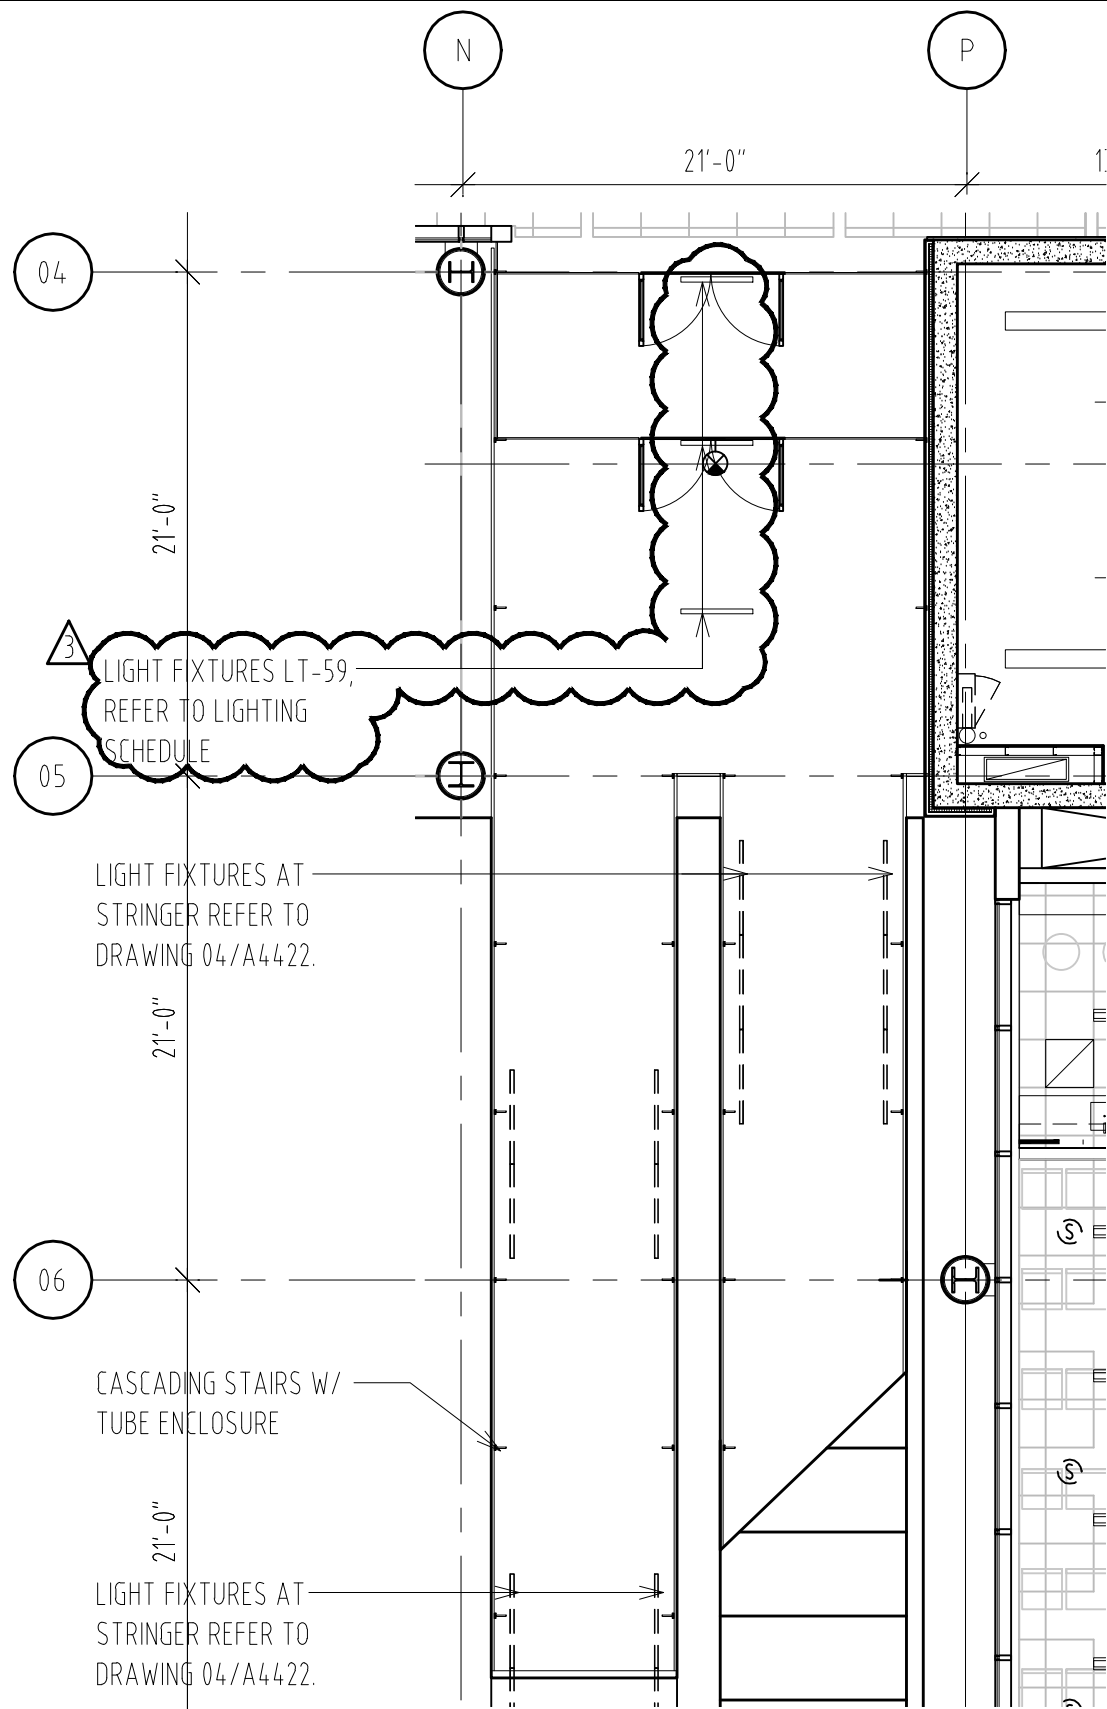

ENLARGED REFLECTED CEILING AND SOFFIT PLAN - LEVEL 3 GRAND STAIR 5 (STAIR 6 OPPOSITE) & VESTIBULE
SCALE 1/8" = 1'-0" 02

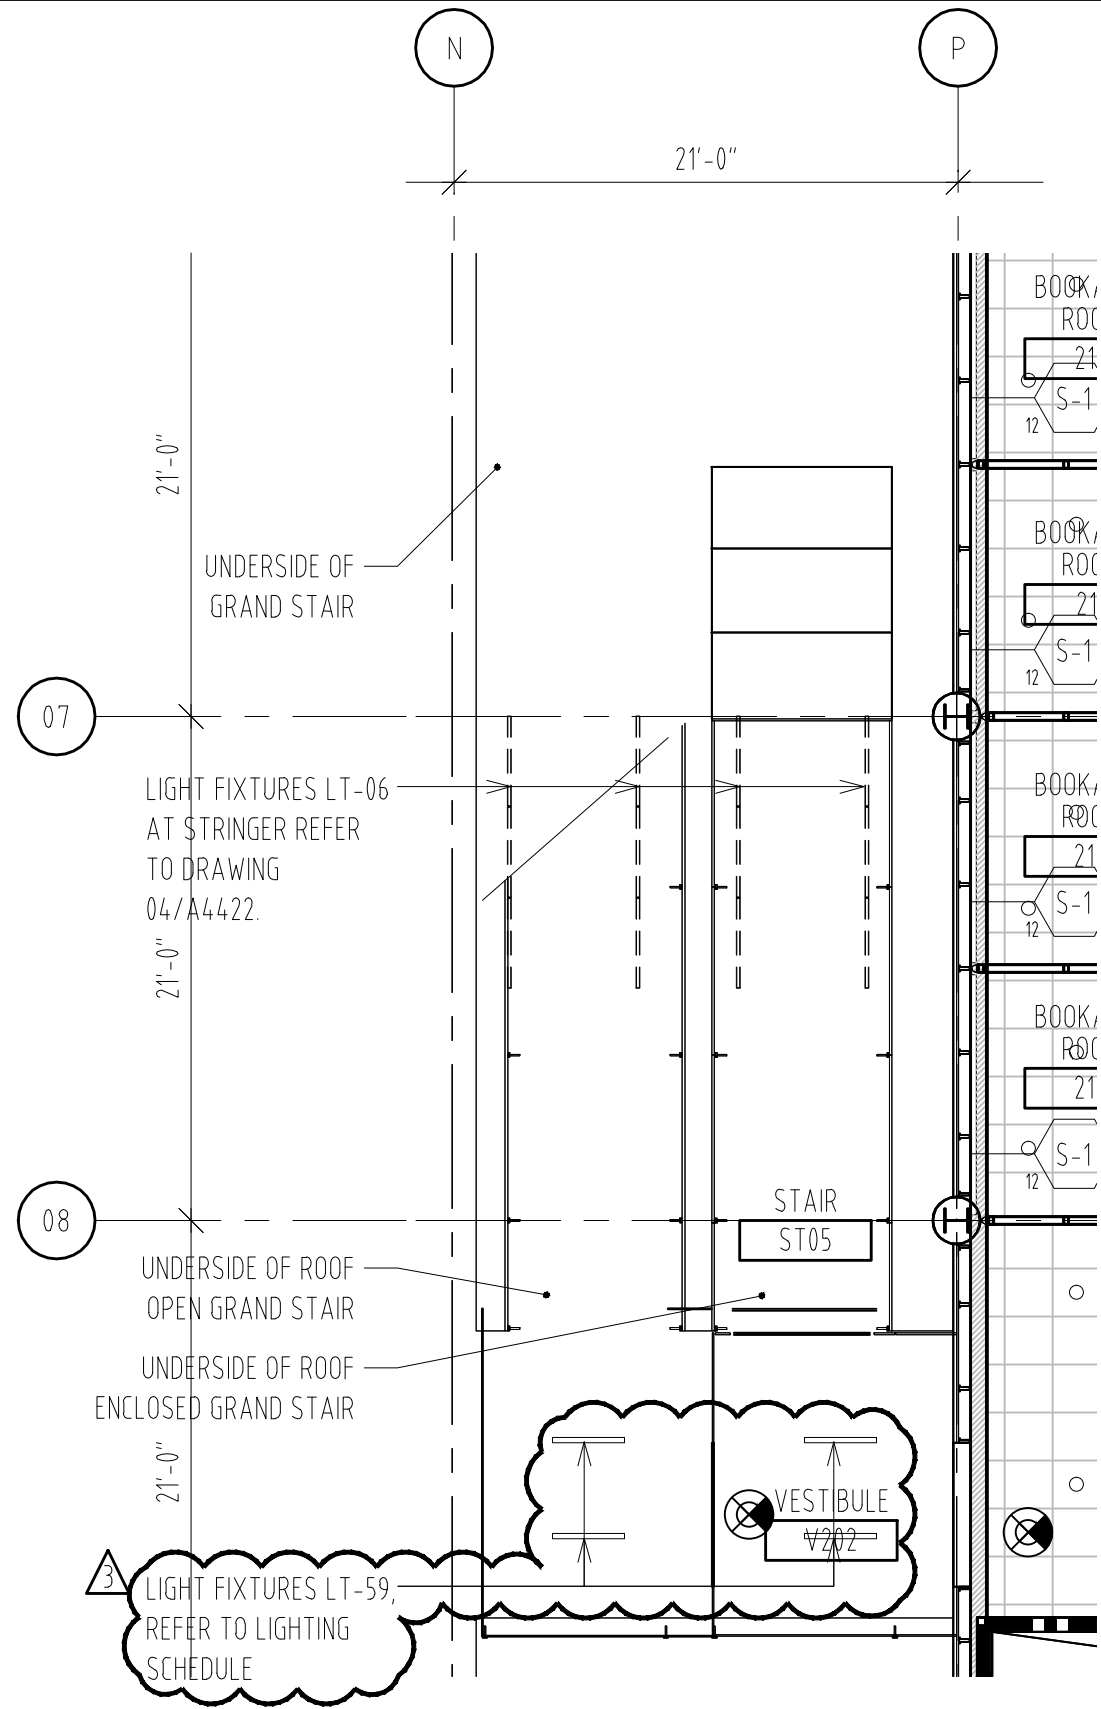

ENLARGED REFLECTED CEILING AND SOFFIT PLAN - LEVEL 2 GRAND STAIR 5 (STAIR 6 OPPOSITE) & VESTIBULE
SCALE 1/8" = 1'-0" 01

MOORE SCHOOL OF BUSINESS
UNIVERSITY OF SOUTH CAROLINA
BID PACKAGE 3
ENCLOSURE/SITE/MEFP/INTERIOR
ADDENDUM #003

PROJECT NO. 655.000

2012.06.22
RAFAEL VINOLY ARCHITECTS PC


ENLARGED REFLECTED CEILING PLAN - GRAND STAIR 5, 6 & VESTIBULES
REF. DWG # A1220B&1230A

SHEET TITLE :

SCALE :
1/8" = 1'-0"

SHEET NUMBER :
A-SK-066



NO.	DATE	NO.	DATE	NO.	DATE
1		1		1	
2		2		2	
3		3		3	
100		100		100	

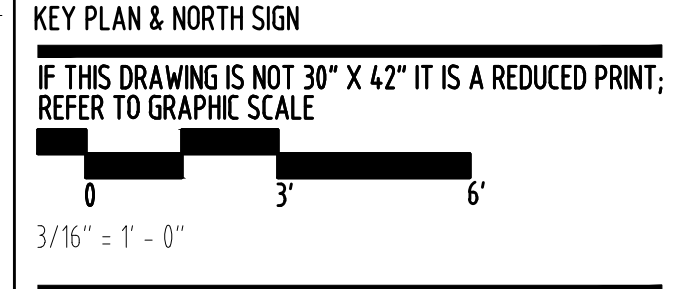



ENLARGED SECTIONS
STAIRS 5 & 6

SHEET TITLE:
A-SK-067

SHEET NUMBER:
01

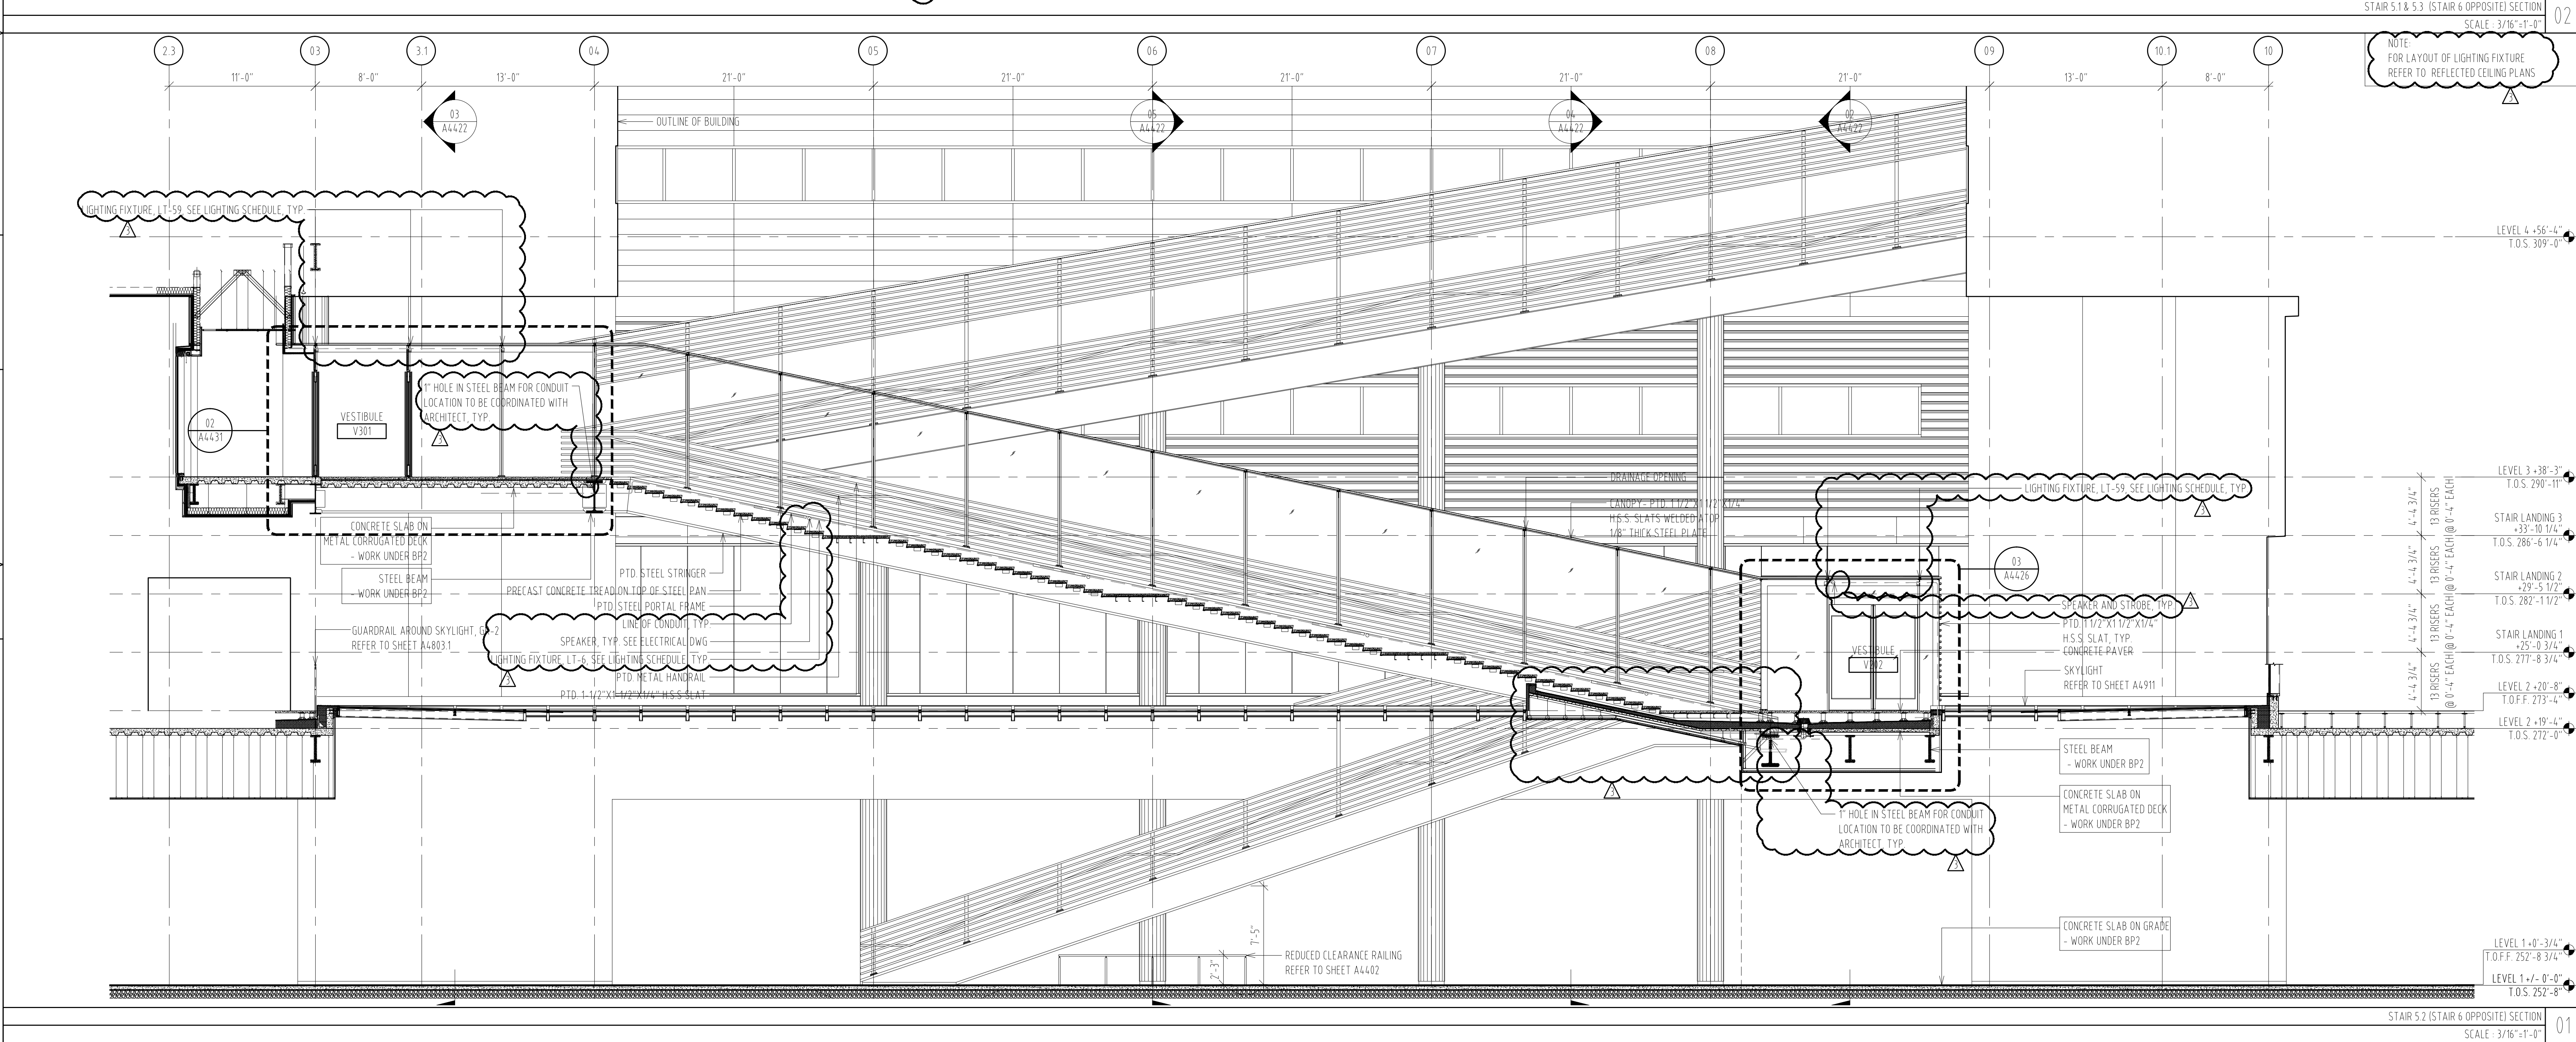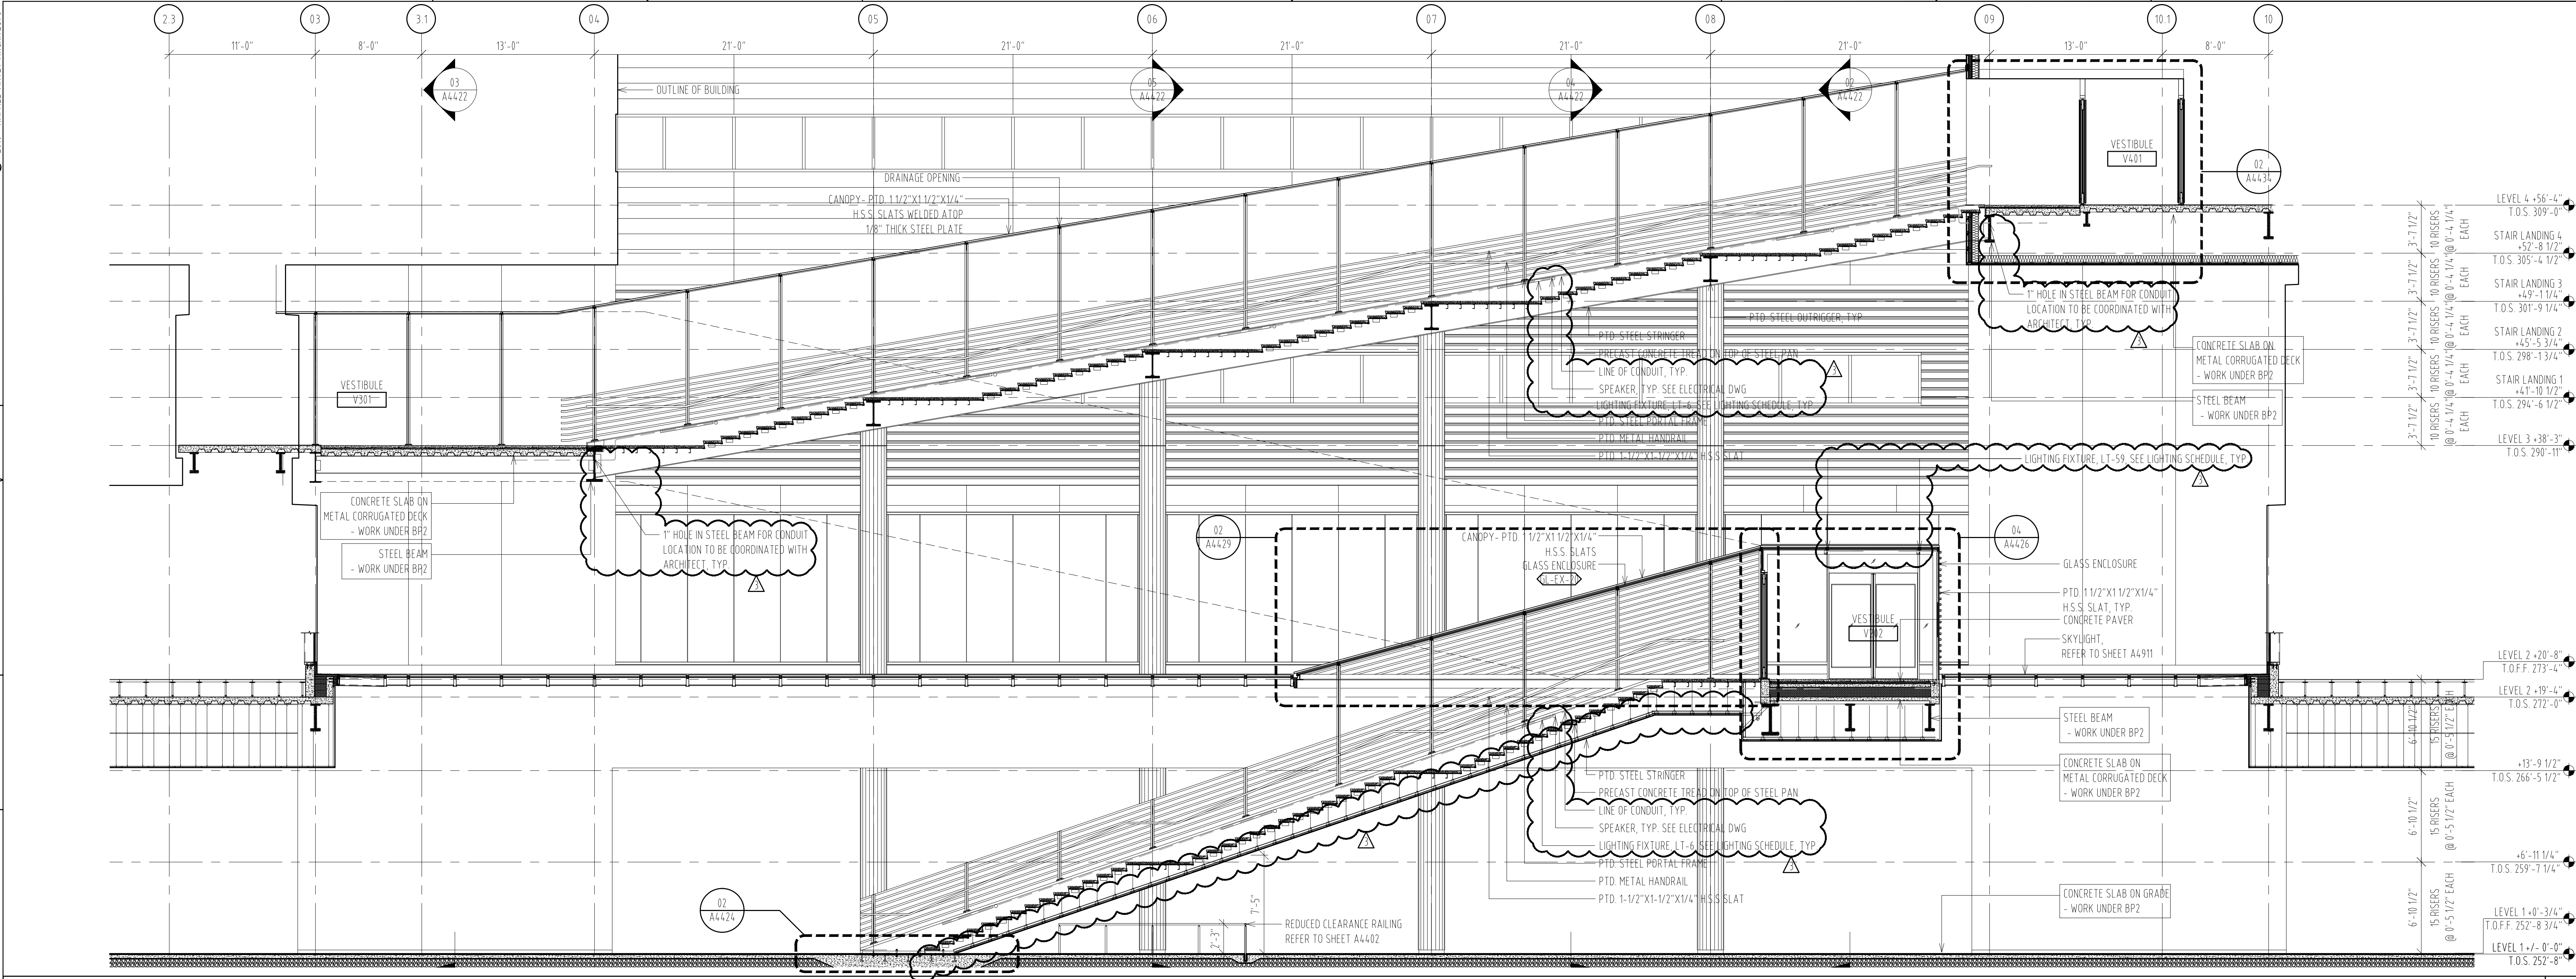

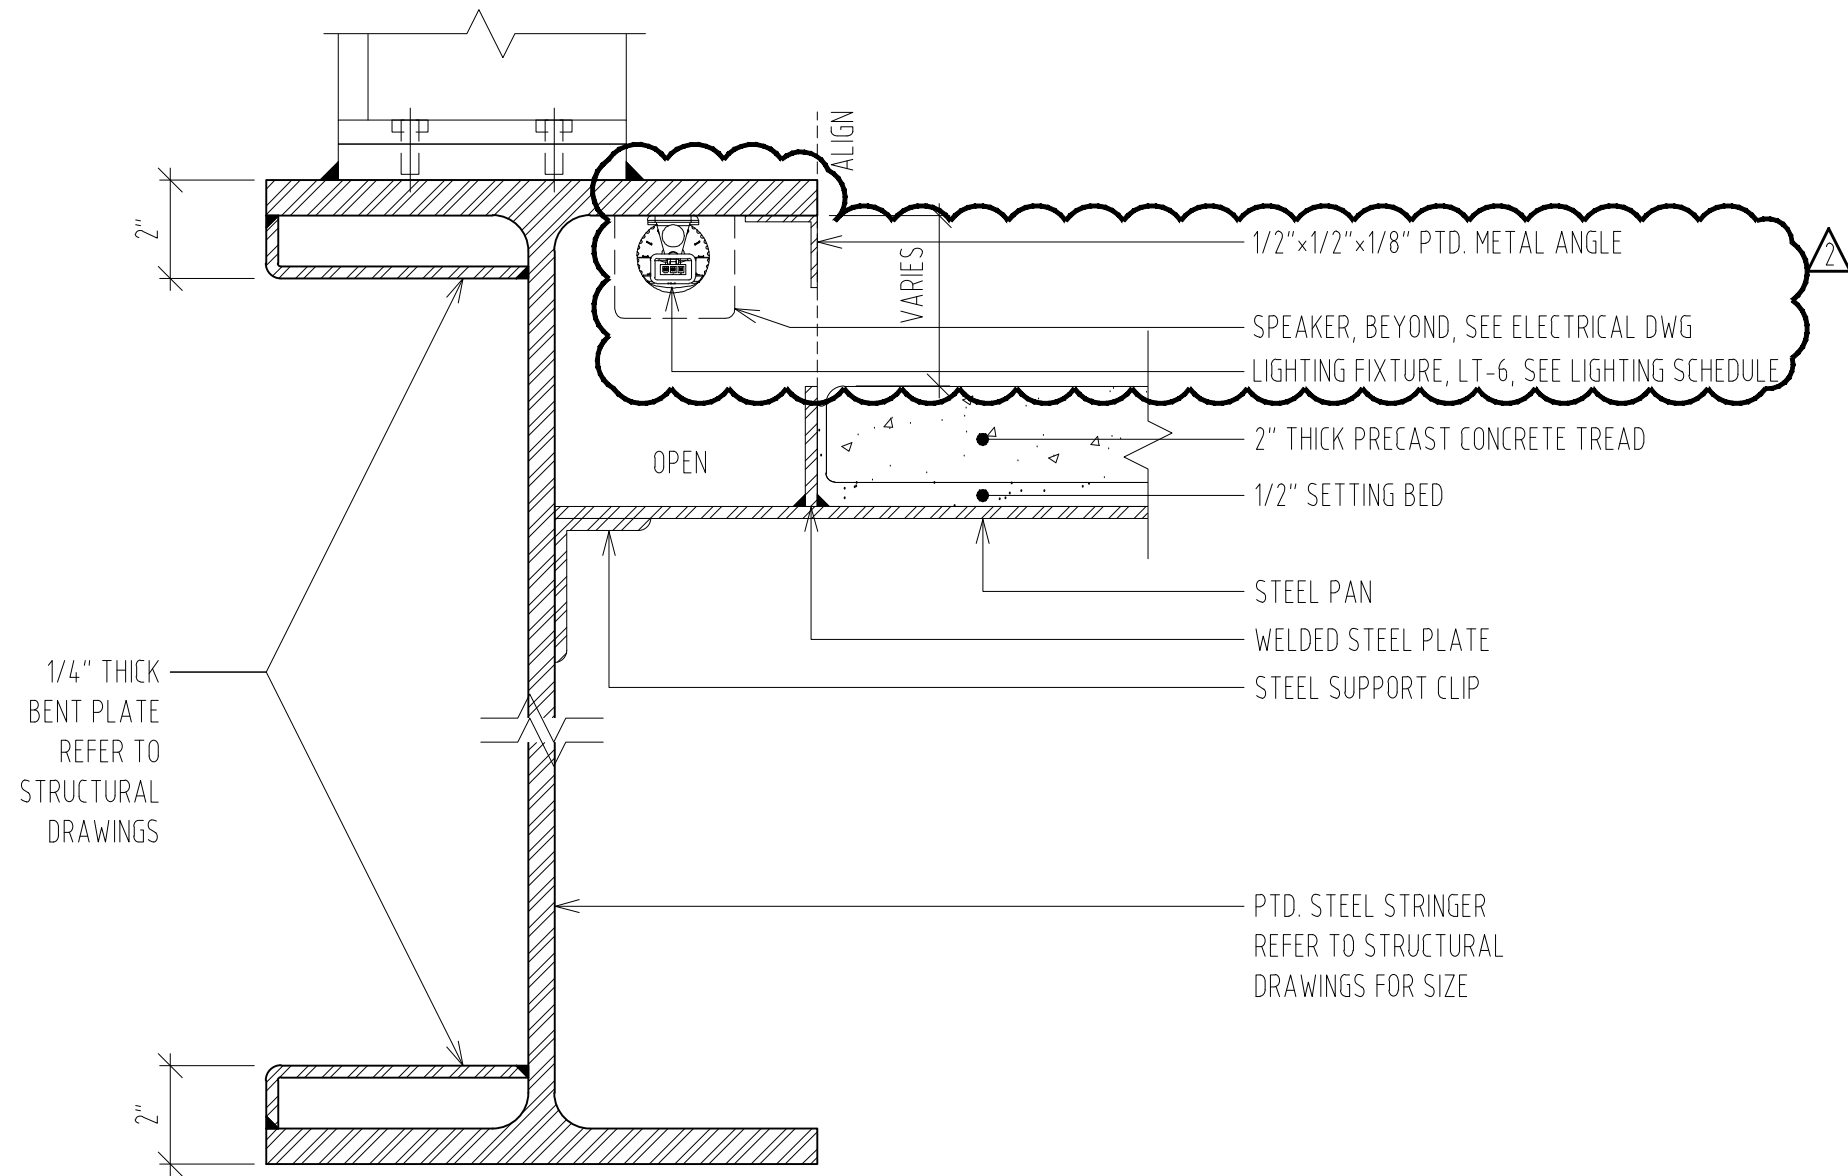

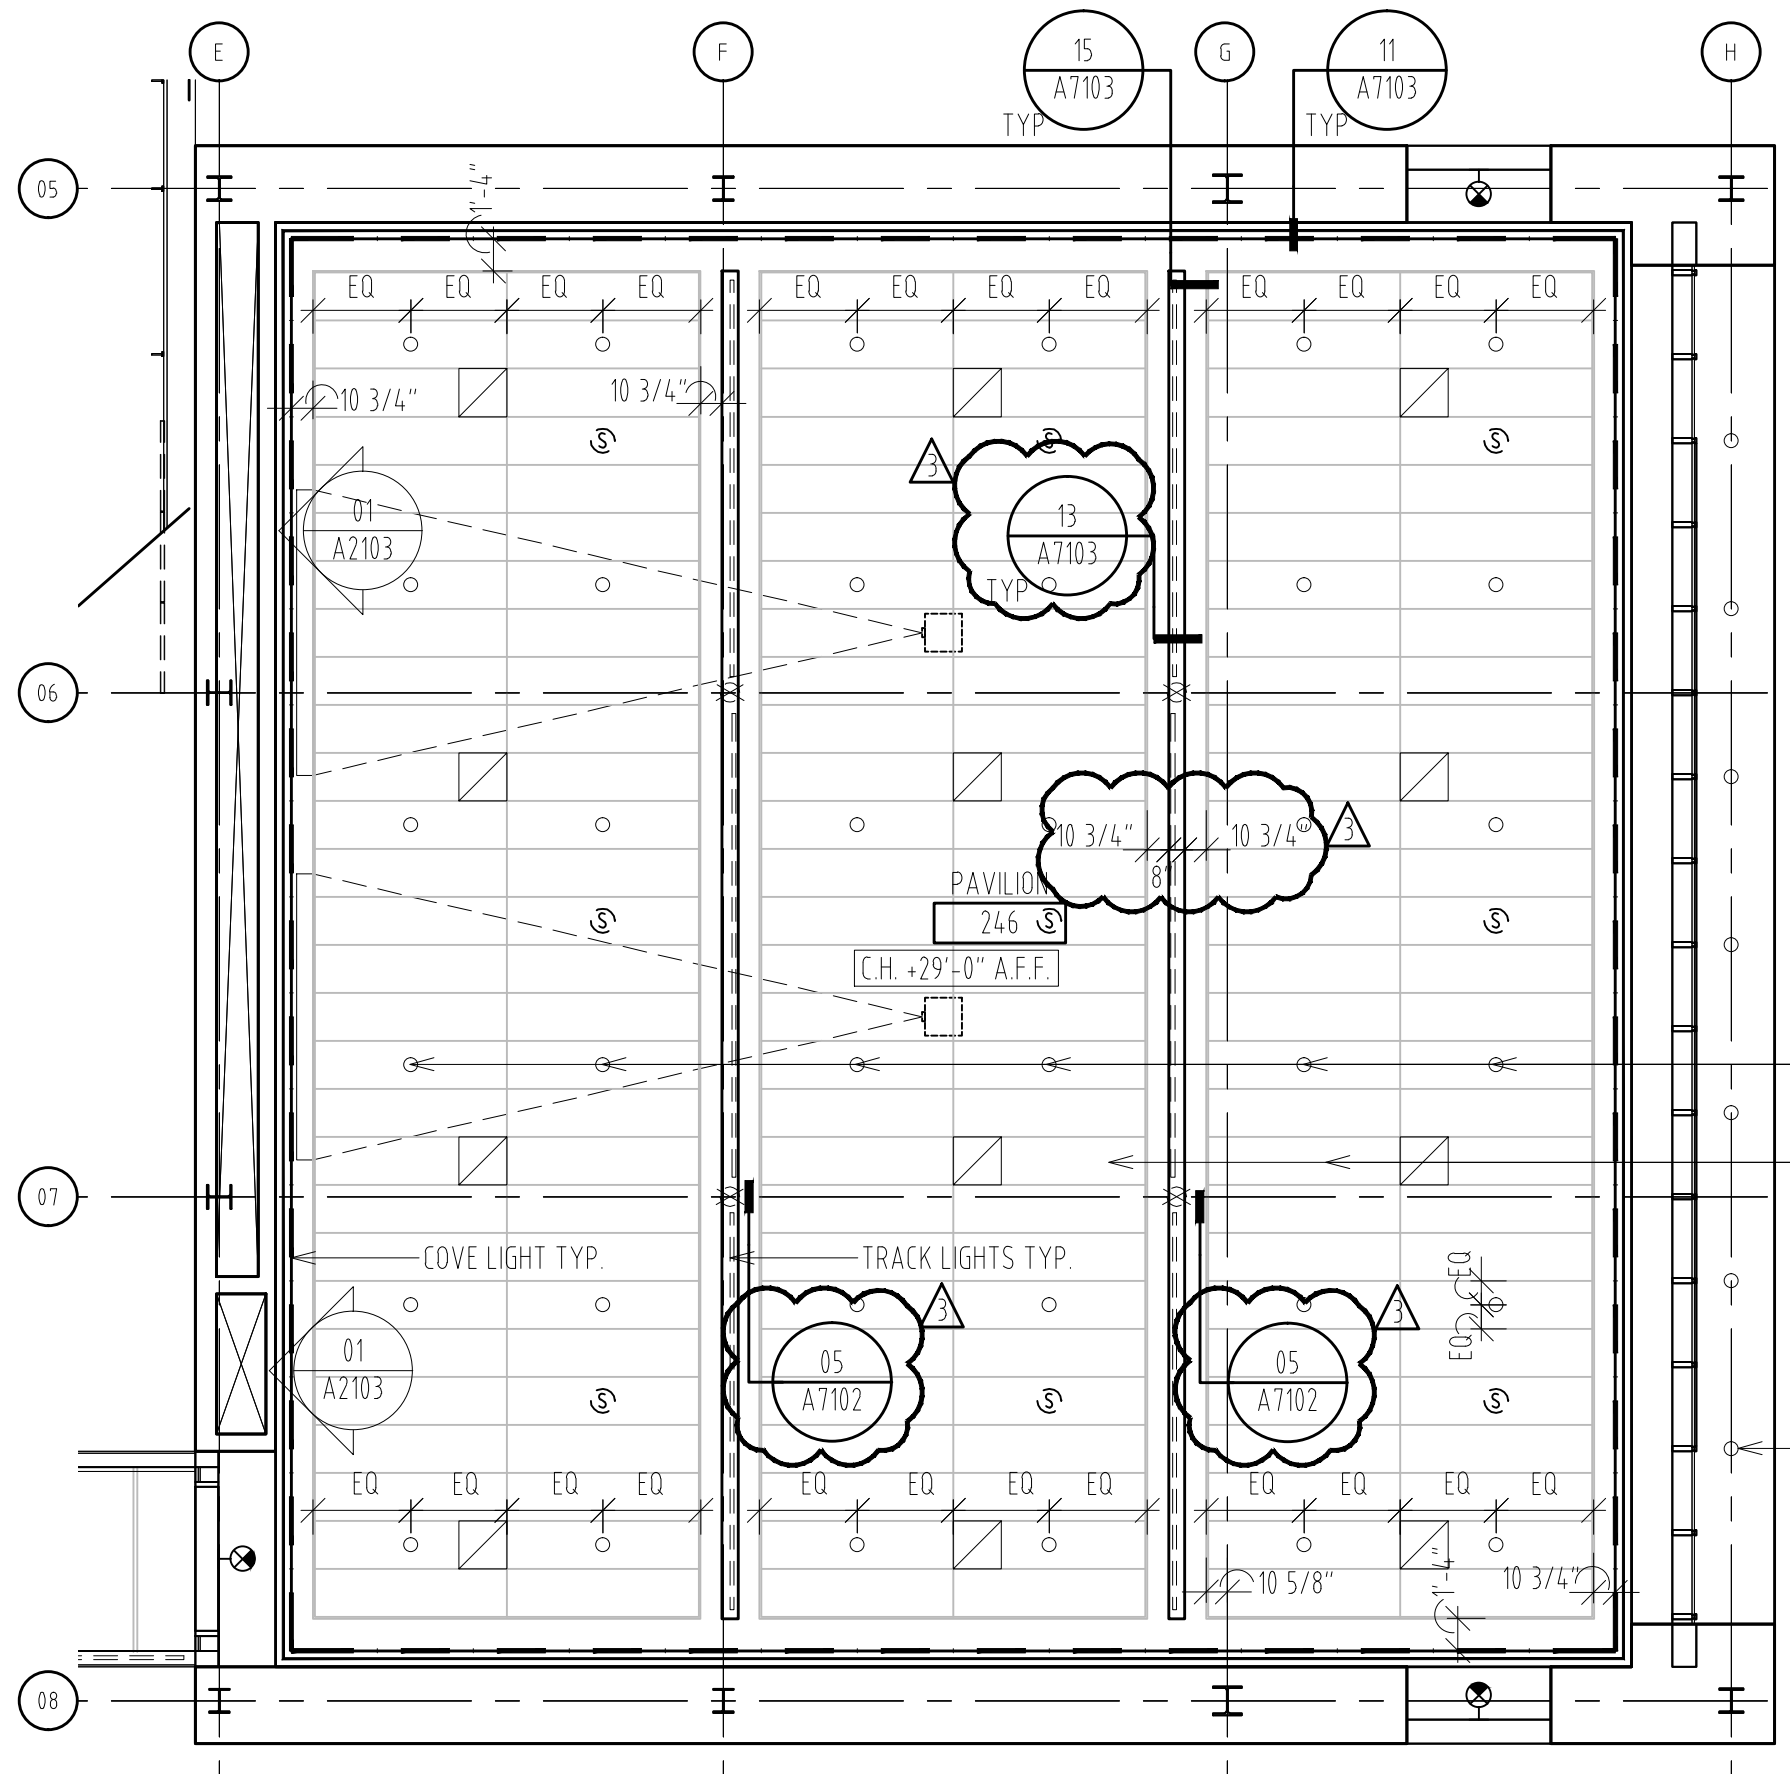

LIGHTING FIXTURE, AS SHOWN, TYP.
(SEE ELECTRICAL DWGS.)

ACT, TYP.
(SEE FINISH SCHEDULE)


LIGHTING FIXTURE, AS SHOWN, TYP.
(SEE ELECTRICAL DWGS.)

MOORE SCHOOL OF BUSINESS
UNIVERSITY OF SOUTH CAROLINA
BID PACKAGE 3
ENCLOSURE/SITE/MEPFP/INTERIOR
ADDENDUM #003
PROJECT NO. 655.000

2012.06.22
RAFAEL VINOLY ARCHITECTS PC


ENLARGED REFLECTED CEILING AND SOFFIT PLAN - LEVEL 2 PAVILION
REF. DWG # A1220C&1220D
SHEET TITLE :

SCALE :
1/8" = 1'-0"
SHEET NUMBER :
A-SK-069

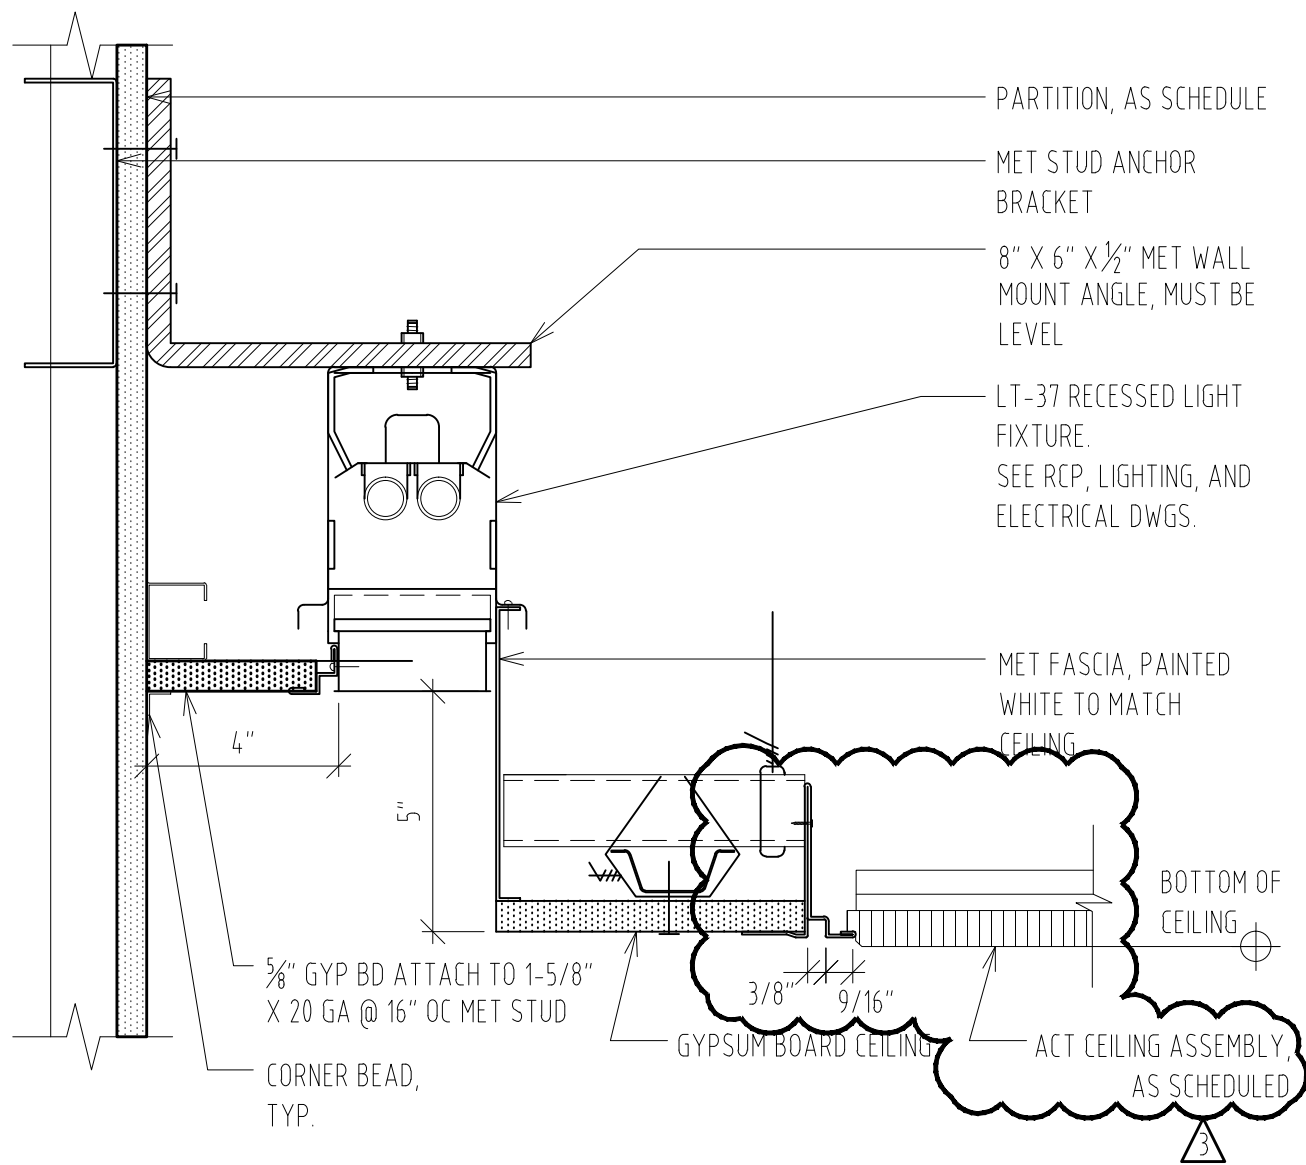

CEILING DETAIL - PAVILION LINEAR EDGE LIGHT
SCALE 3" = 1'-0"

02

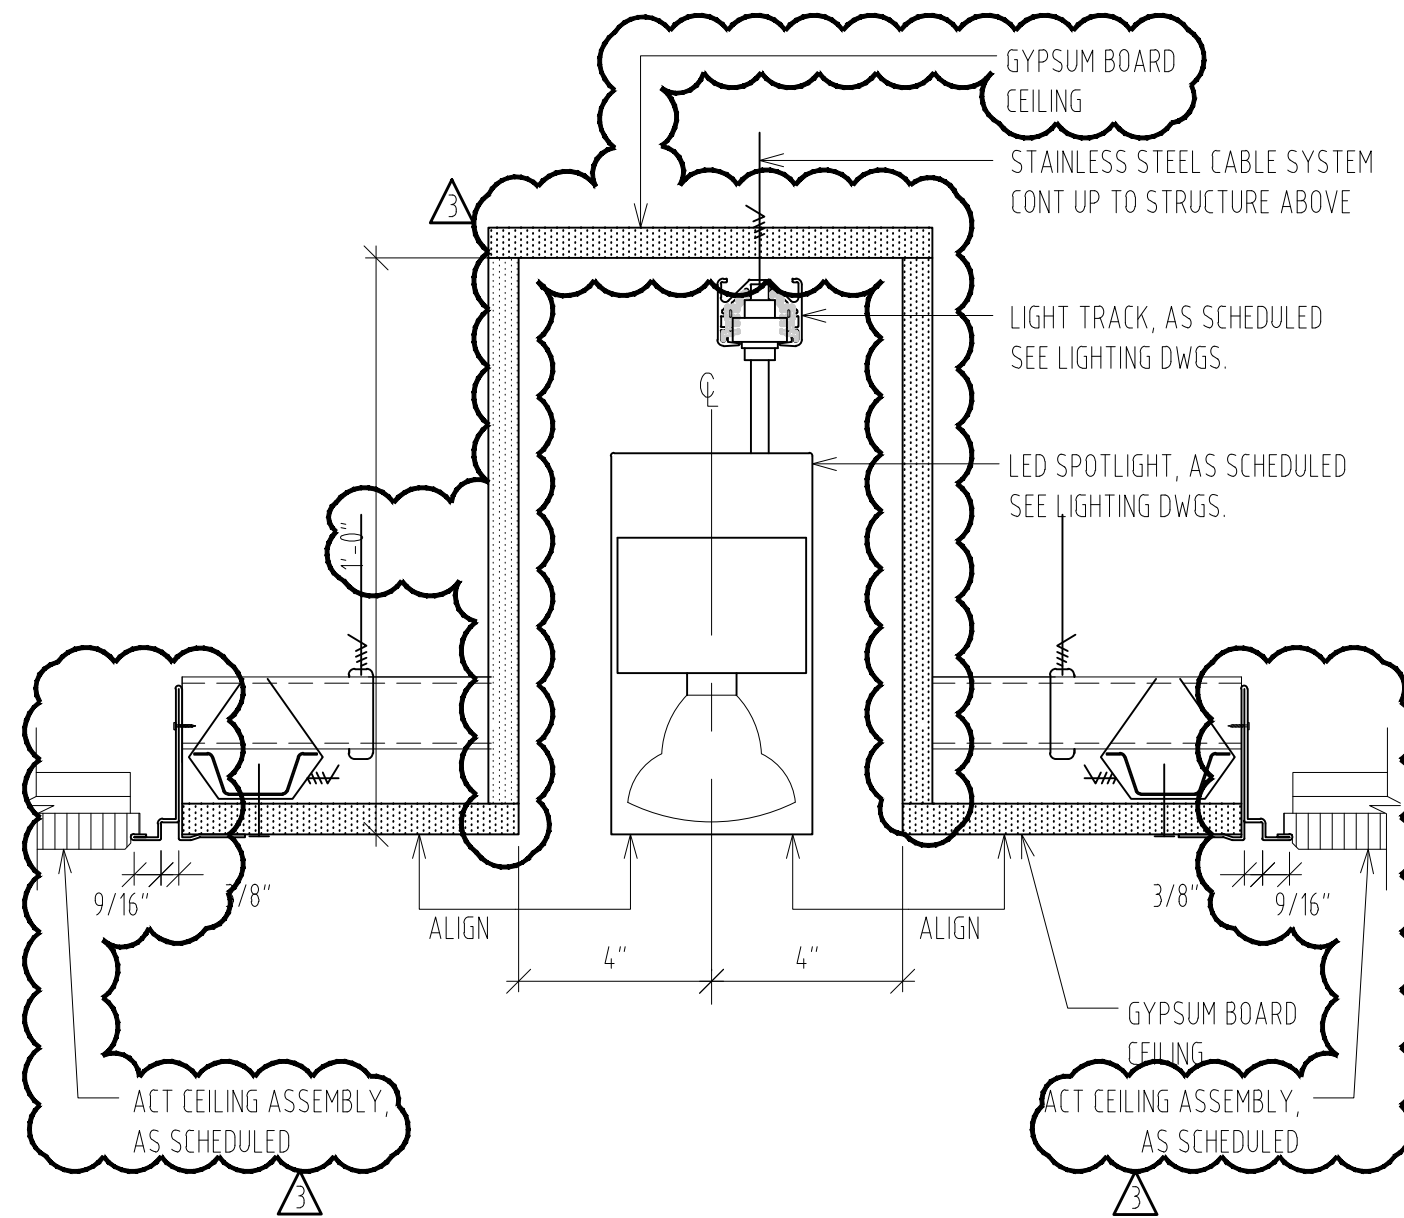


NOTE:
CROSS-REFERENCED EXAMPLE:
DRAWING SHEET A5260

CEILING DETAIL - PAVILION LED SPOT LIGHT
SCALE 3" = 1'-0"

01

GENERAL NOTE:
 1. REFER TO A1140 SERIES DWG, FOR OVERALL GUARDRAIL LENGTH AND LAYOUT INFORMATION
 2. REFER TO LIGHTING FIXTURE SCHEDULE, FOR INTEGRAL LED HANDRAIL INFORMATION
 3. REQUIRED GUARDS SHALL NOT HAVE OPENINGS WHICH ALLOW PASSAGE OF A SPHERE 4" IN DIAMETER FROM THE WALKING SURFACE TO THE REQUIRED GUARD HEIGHT, REFER TO IBC SECTION 1013


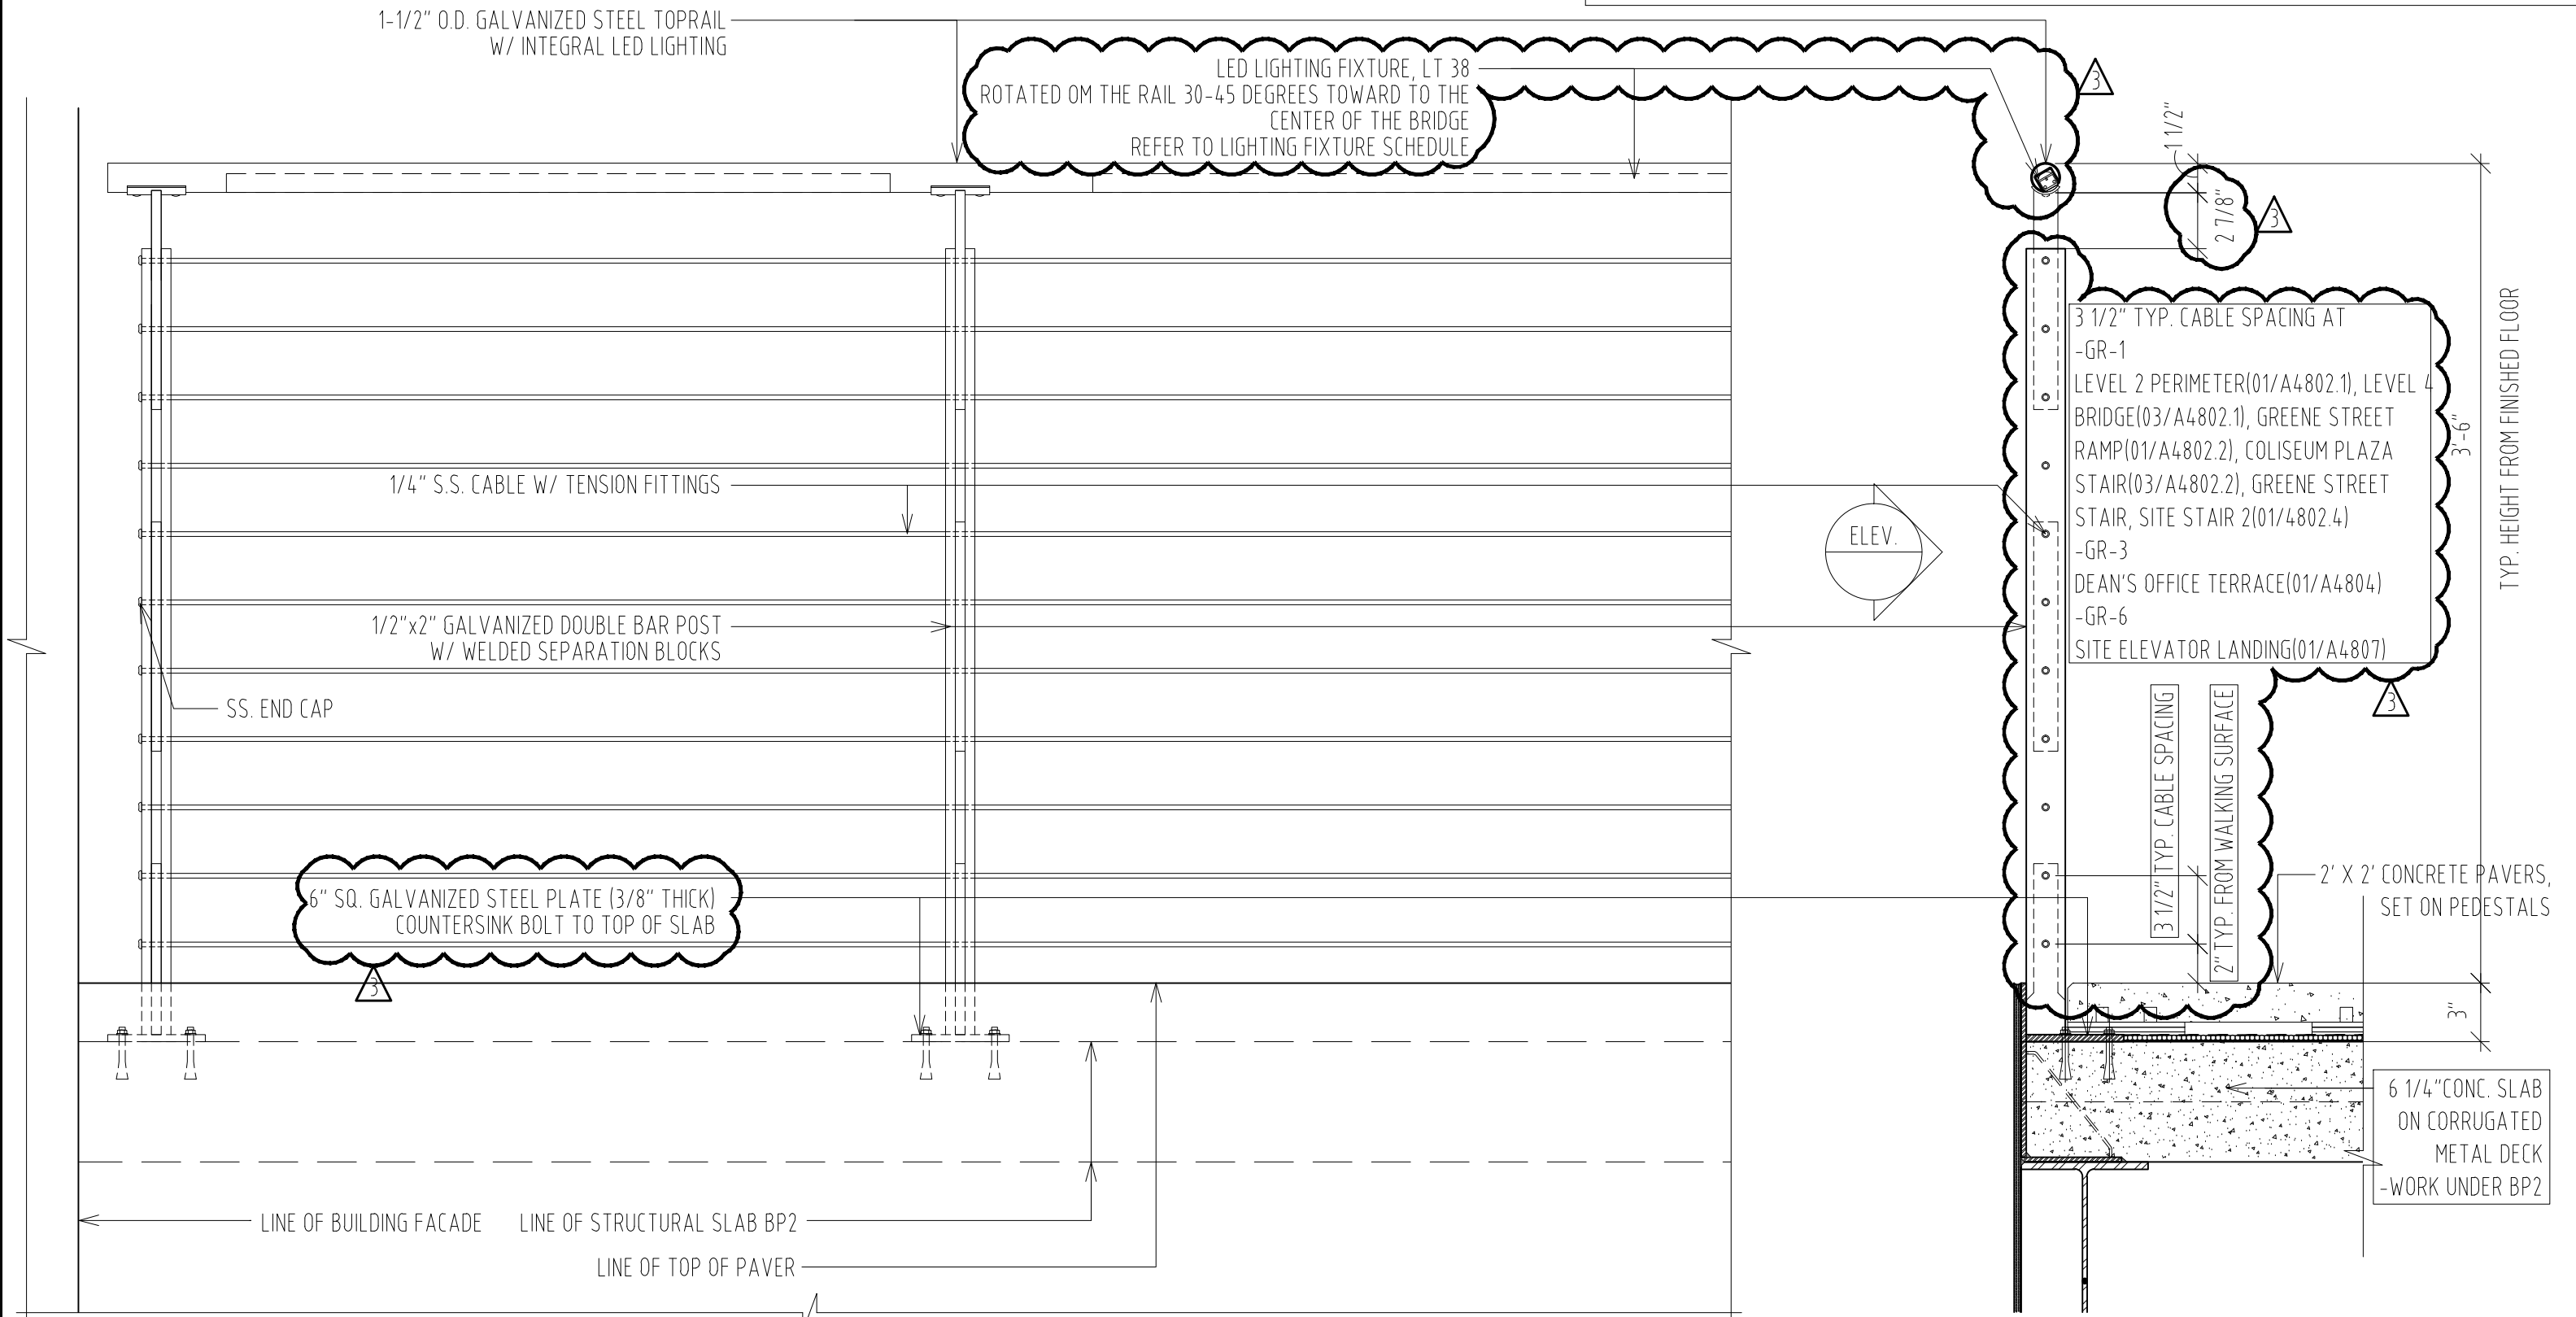


MOORE SCHOOL OF BUSINESS
 UNIVERSITY OF SOUTH CAROLINA
 BID PACKAGE 3
 ENCLOSURE/SITE/MEPFP/INTERIOR
 ADDENDUM #001
 PROJECT NO. 655.000


2012.06.22
 RAFAEL VINOLY ARCHITECTS PC

EXTERIOR GUARDRAIL AT LEVEL 4 BRIDGE - GR-1 - SECTION, ELEVATION
 & TYPICAL CABLE SPACING REVISION REF. DWG # 03/A4802.1
 SHEET TITLE :

SCALE :
 1 1/2" = 1'-0"
 SHEET NUMBER :
 A-SK-071

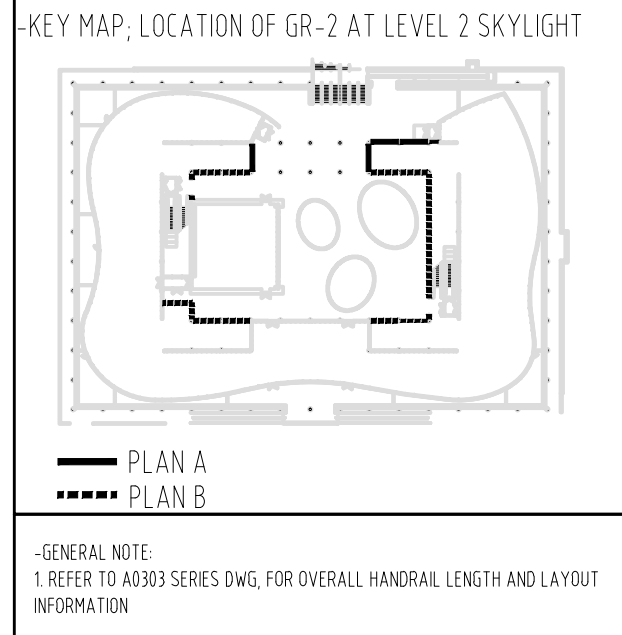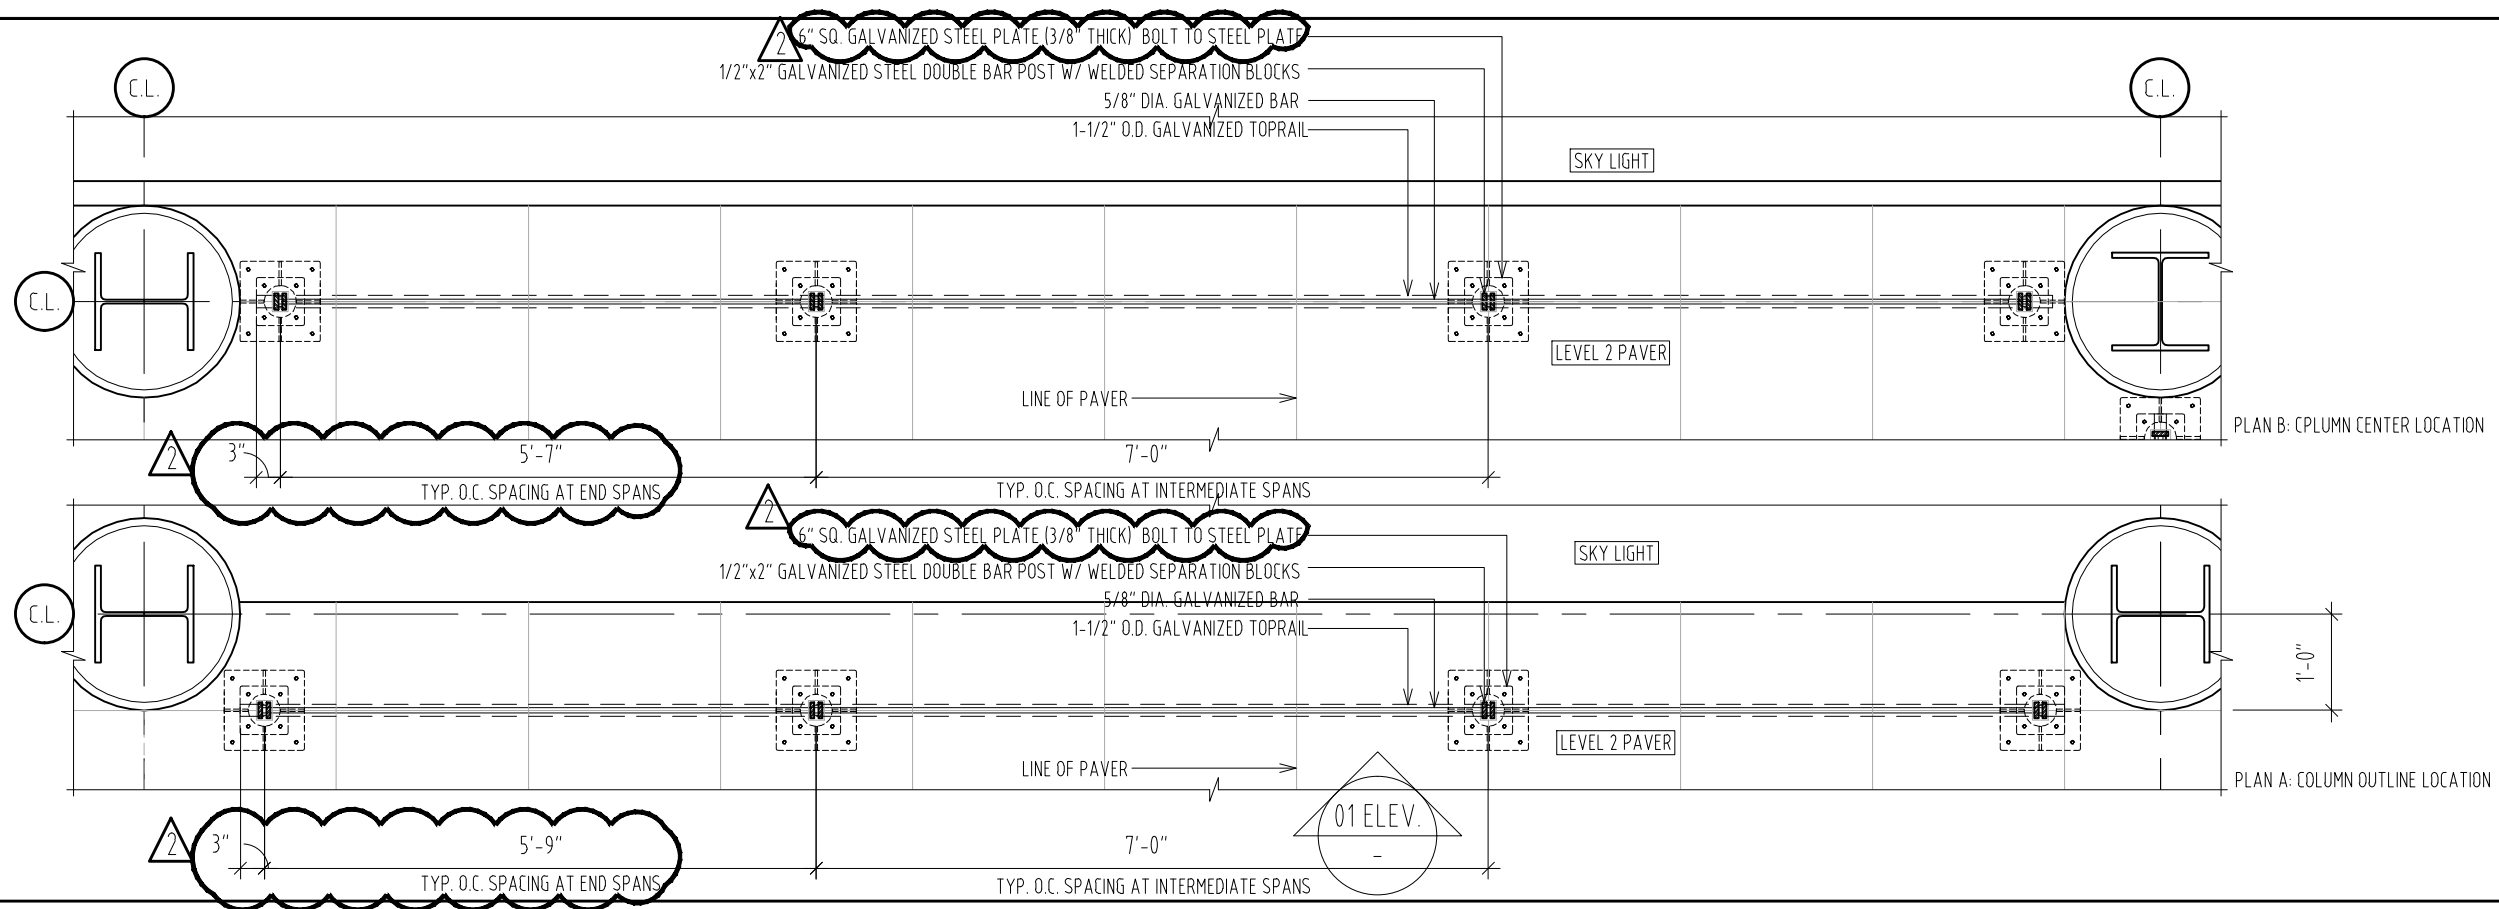

EXTERIOR GUARDRAIL AT LEVEL 2 SKYLIGHT (COLUMN OUTLINE LOCATION) - GR-2 - PLAN
 SCALE 1/2" = 1'-0" 02

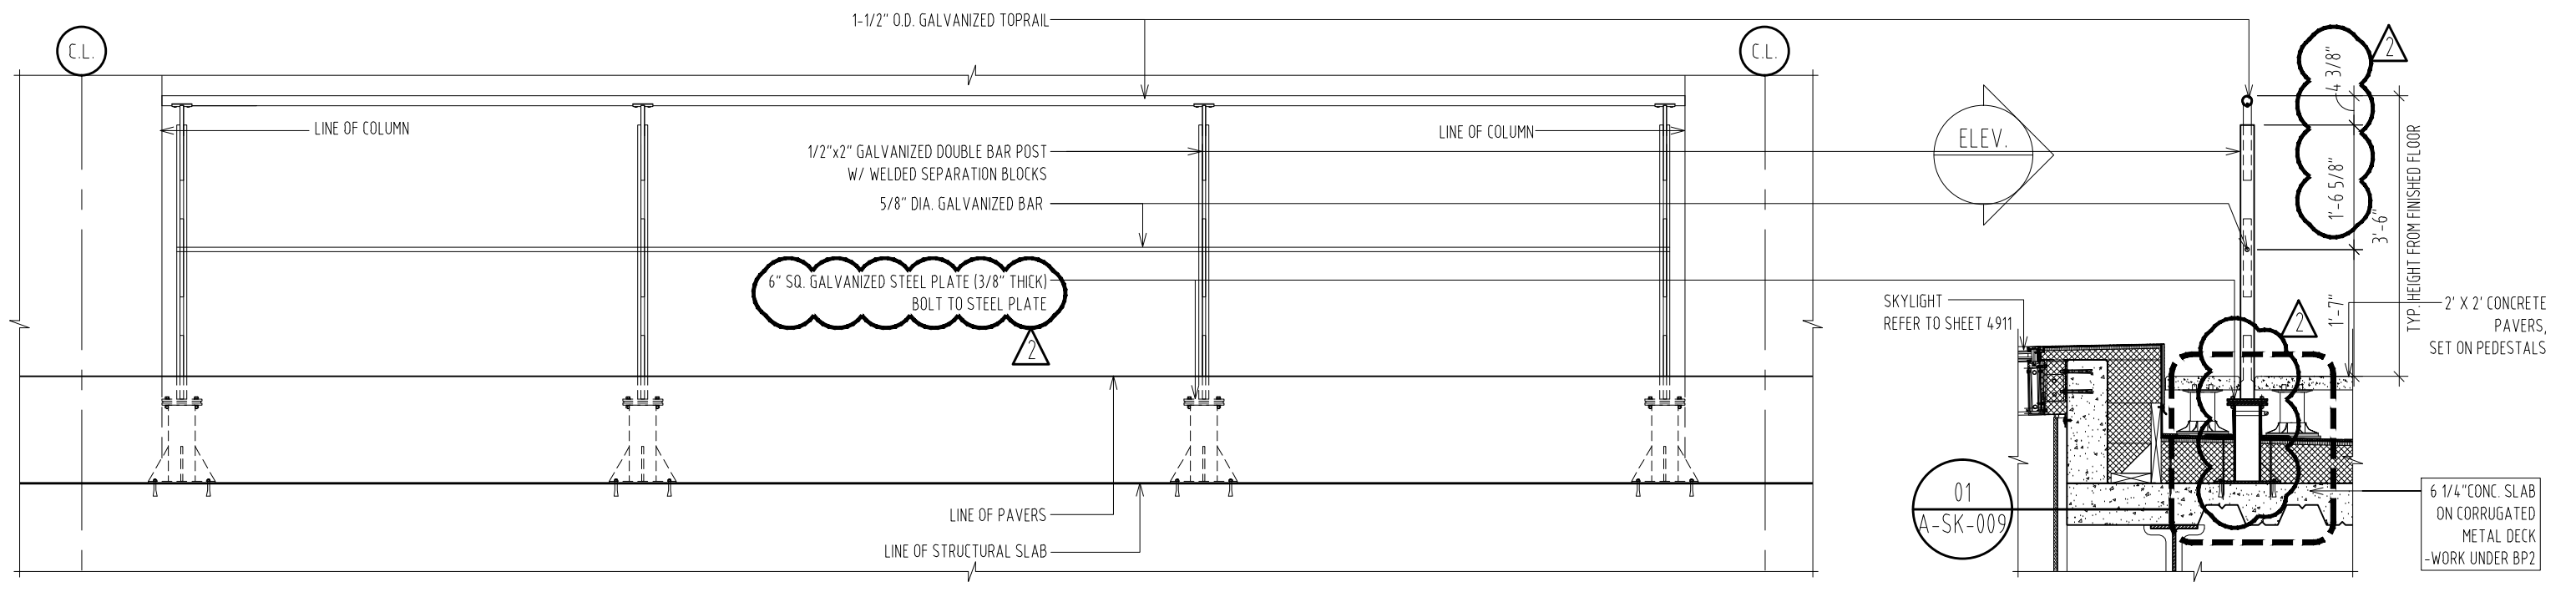


EXTERIOR GUARDRAIL AT LEVEL 2 SKYLIGHT - GR-2 - SECTION & ELEVATION
 SCALE 1/2" = 1'-0" 01

MOORE SCHOOL OF BUSINESS
 UNIVERSITY OF SOUTH CAROLINA
 BID PACKAGE 3
 ENCLOSURE/SITE/MEPFP/INTERIOR
 ADDENDUM #003
 PROJECT NO. 655.000


2012.06.22
 RAFAEL VINOLY ARCHITECTS PC

ENLARGED SECTION, ELEVATION, AND PLAN EXTERIOR GUARDRAIL GR-2 AT LEVEL 2 SKYLIGHT
 REF. DWG # 01,02,03/A4803.1
 SHEET TITLE :

SCALE :
 1/2" = 1'-0"
 SHEET NUMBER :
 A-SK-072

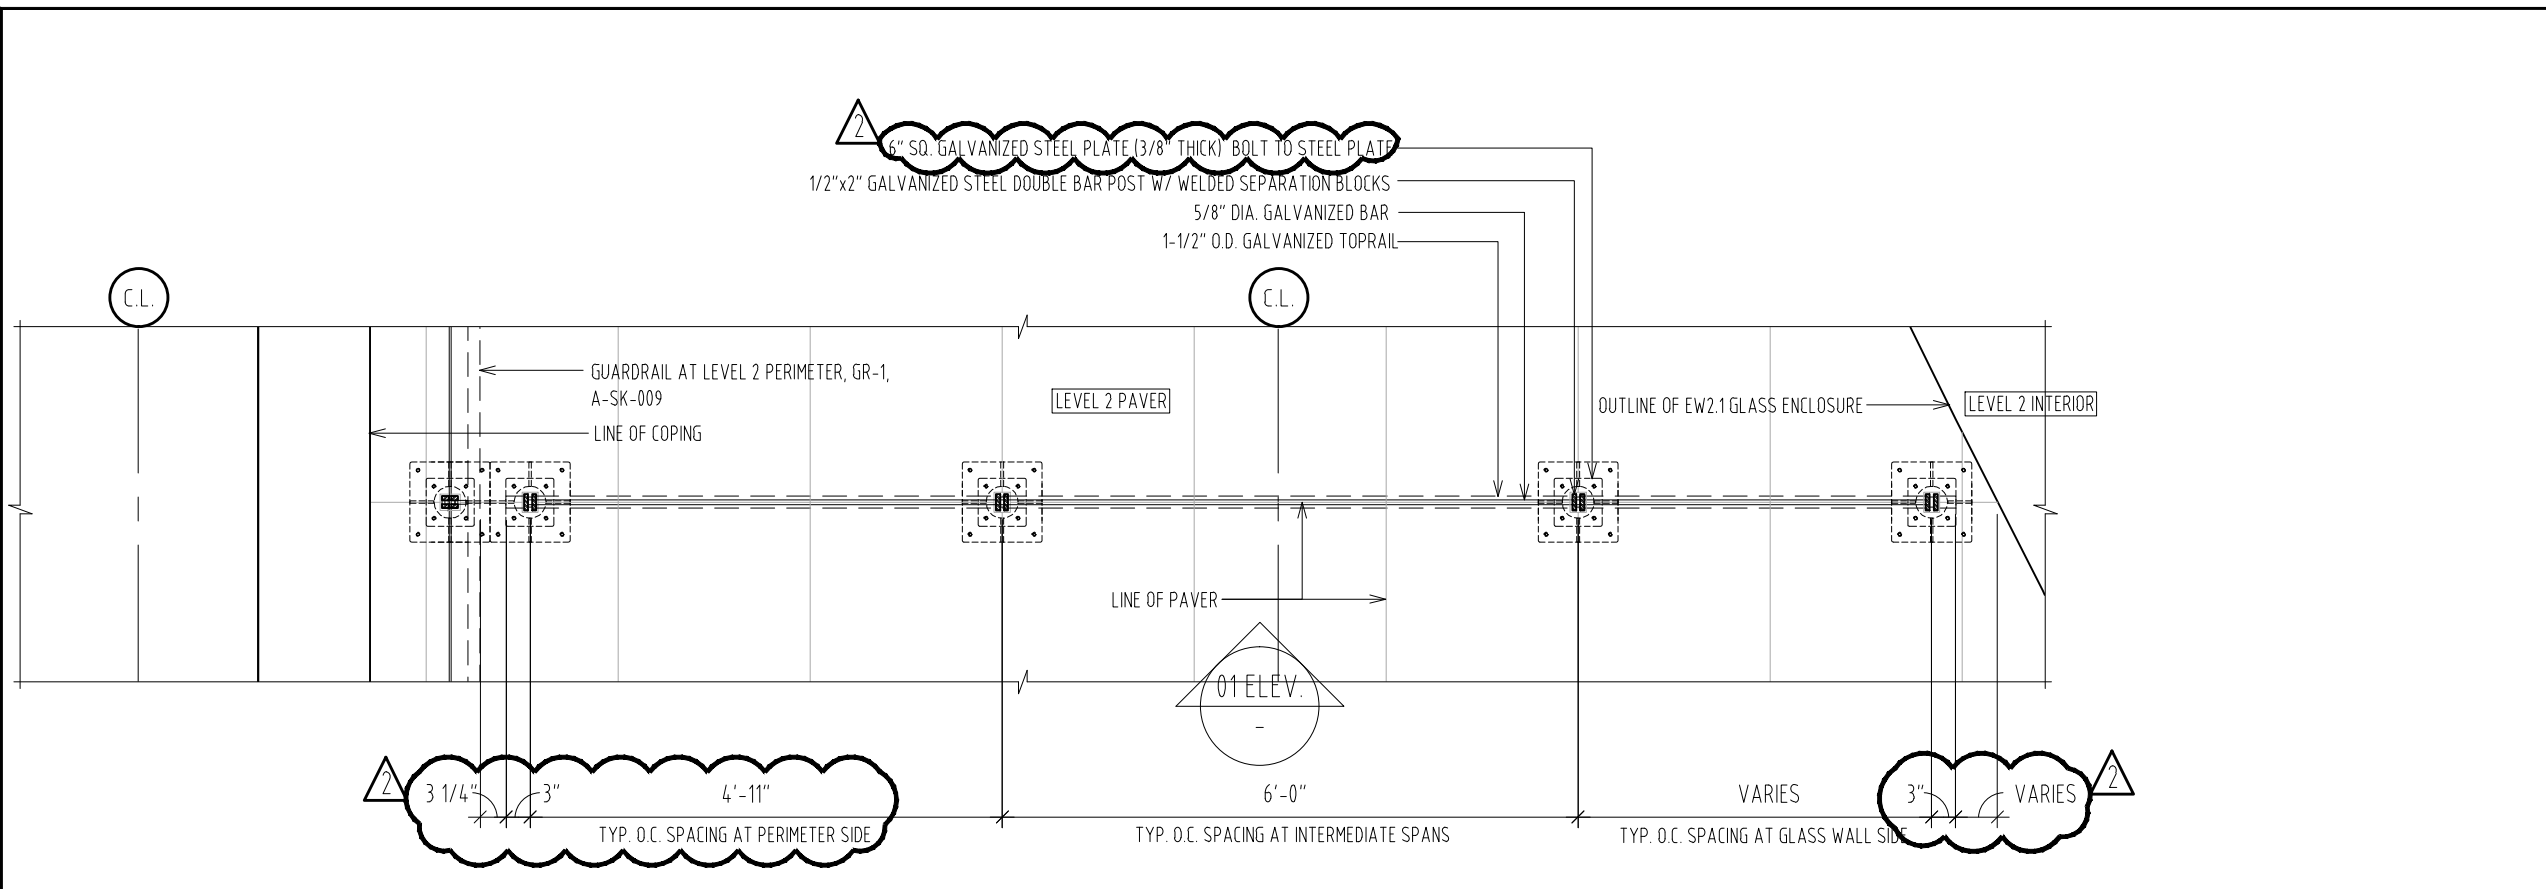



-KEY MAP; LOCATION OF GR-2 AT LEVEL 2

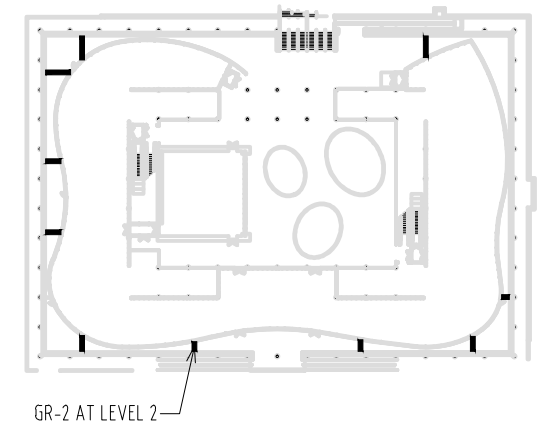

-GENERAL NOTE:
1. REFER TO A0303 SERIES DWG, FOR OVERALL HANDRAIL LENGTH AND LAYOUT INFORMATION

EXTERIOR GUARDRAIL AT LEVEL 2 - GR-2 - PLAN
SCALE 1/2" = 1'-0"

02

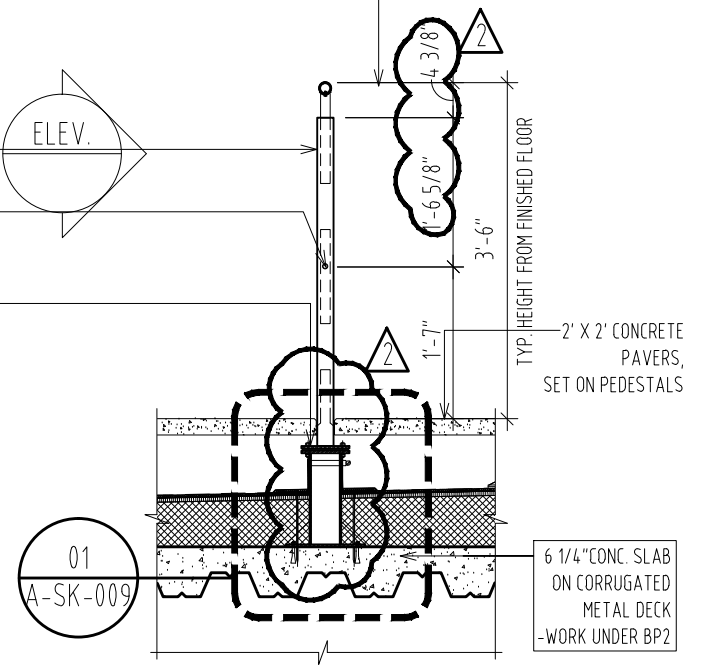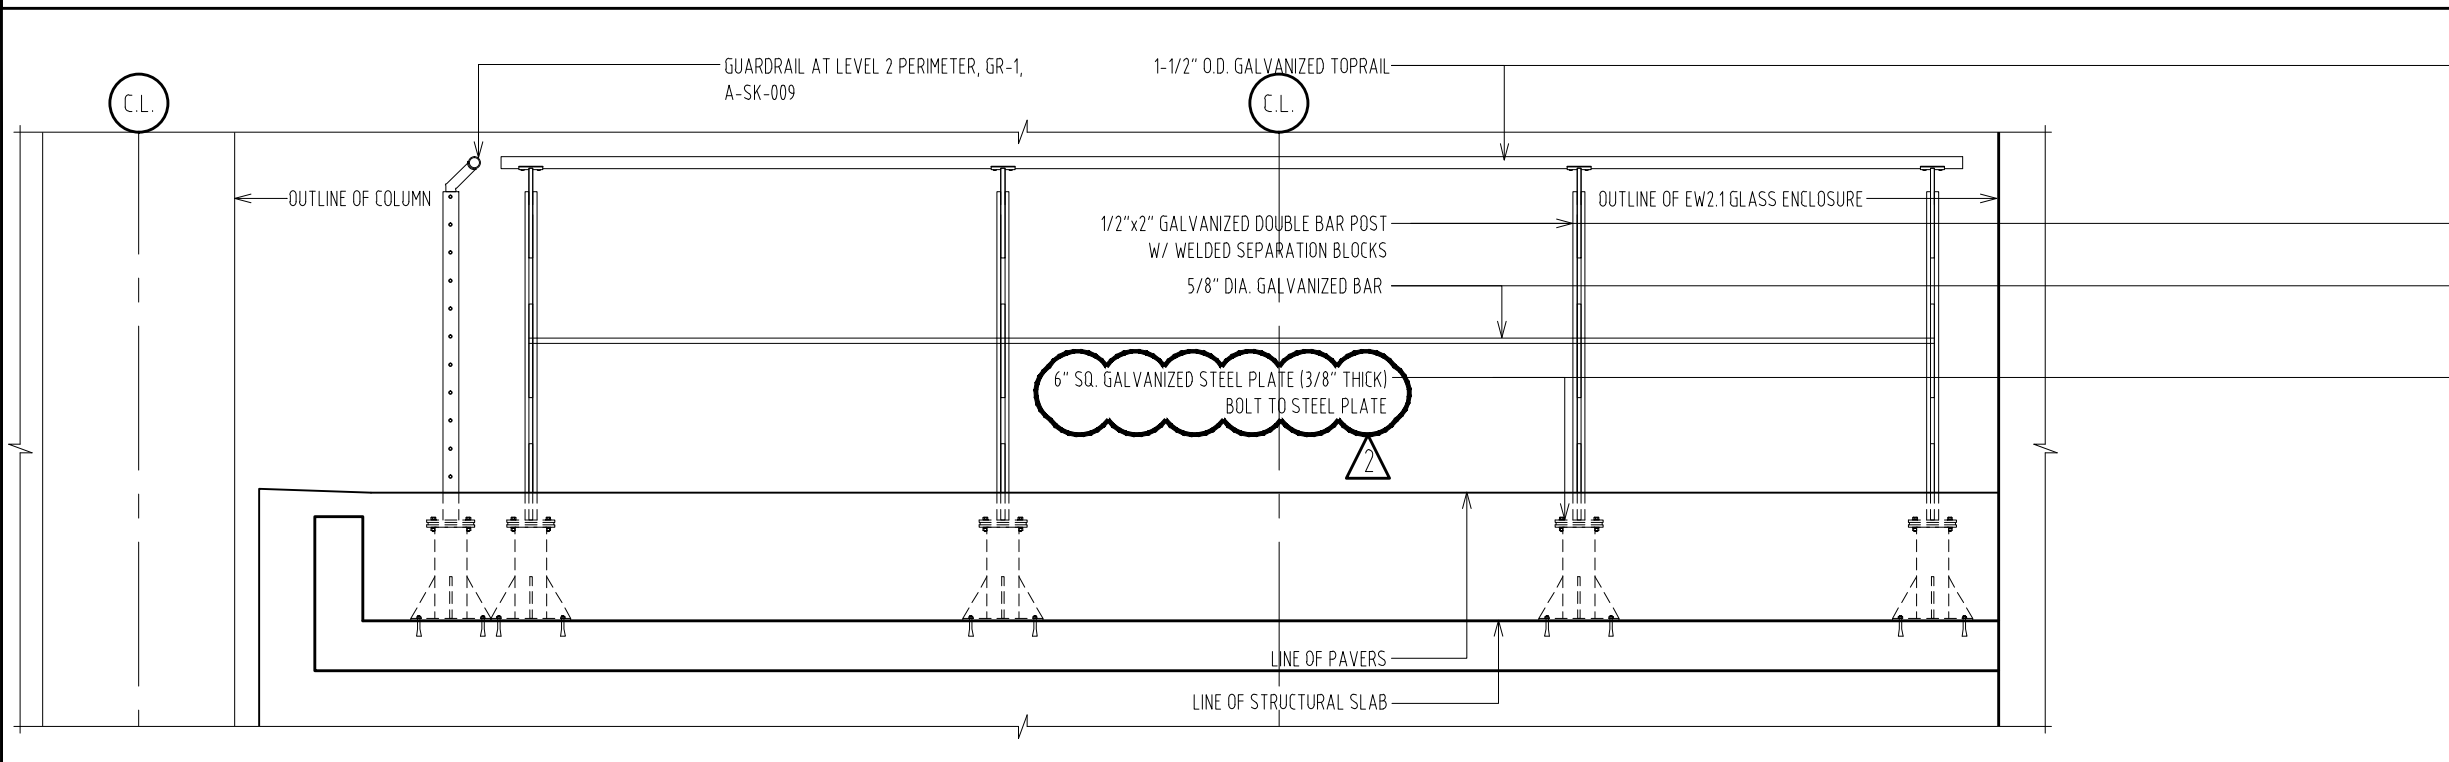

EXTERIOR GUARDRAIL AT LEVEL 2 - GR-2 - SECTION & ELEVATION
SCALE 1/2" = 1'-0"

01


MOORE SCHOOL OF BUSINESS
UNIVERSITY OF SOUTH CAROLINA
BID PACKAGE 3
ENCLOSURE/SITE/MEFP/INTERIOR
ADDENDUM #003
PROJECT NO. 655.000

2012.06.22
RAFAEL VINOLY ARCHITECTS PC


ENLARGED SECTION, ELEVATION, AND PLAN EXTERIOR GUARDRAIL GR-2 AT LEVEL 2 & ROOF
REF. DWG # 04,05/A4803.1 & 01/A4803.2
SHEET TITLE :

SCALE :
1/2" = 1'-0"
SHEET NUMBER :
A-SK-073

-KEY MAP; LOCATION OF GR-4 AT RETAINING WALL

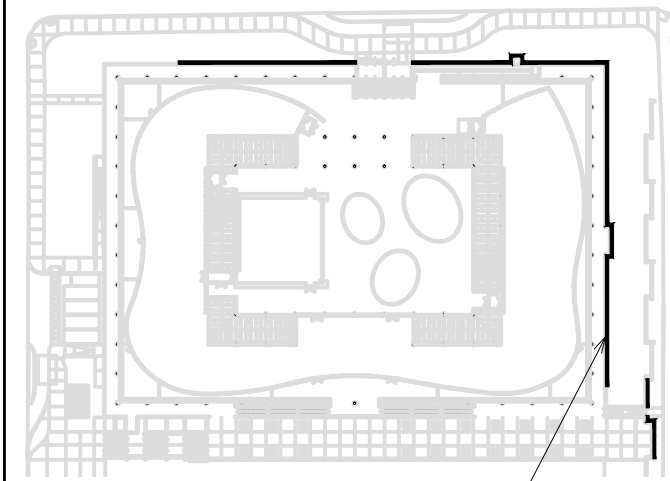


-GENERAL NOTE:
1. REFER TO A0303 SERIES DWG, FOR OVERALL HANDRAIL LENGTH AND LAYOUT INFORMATION

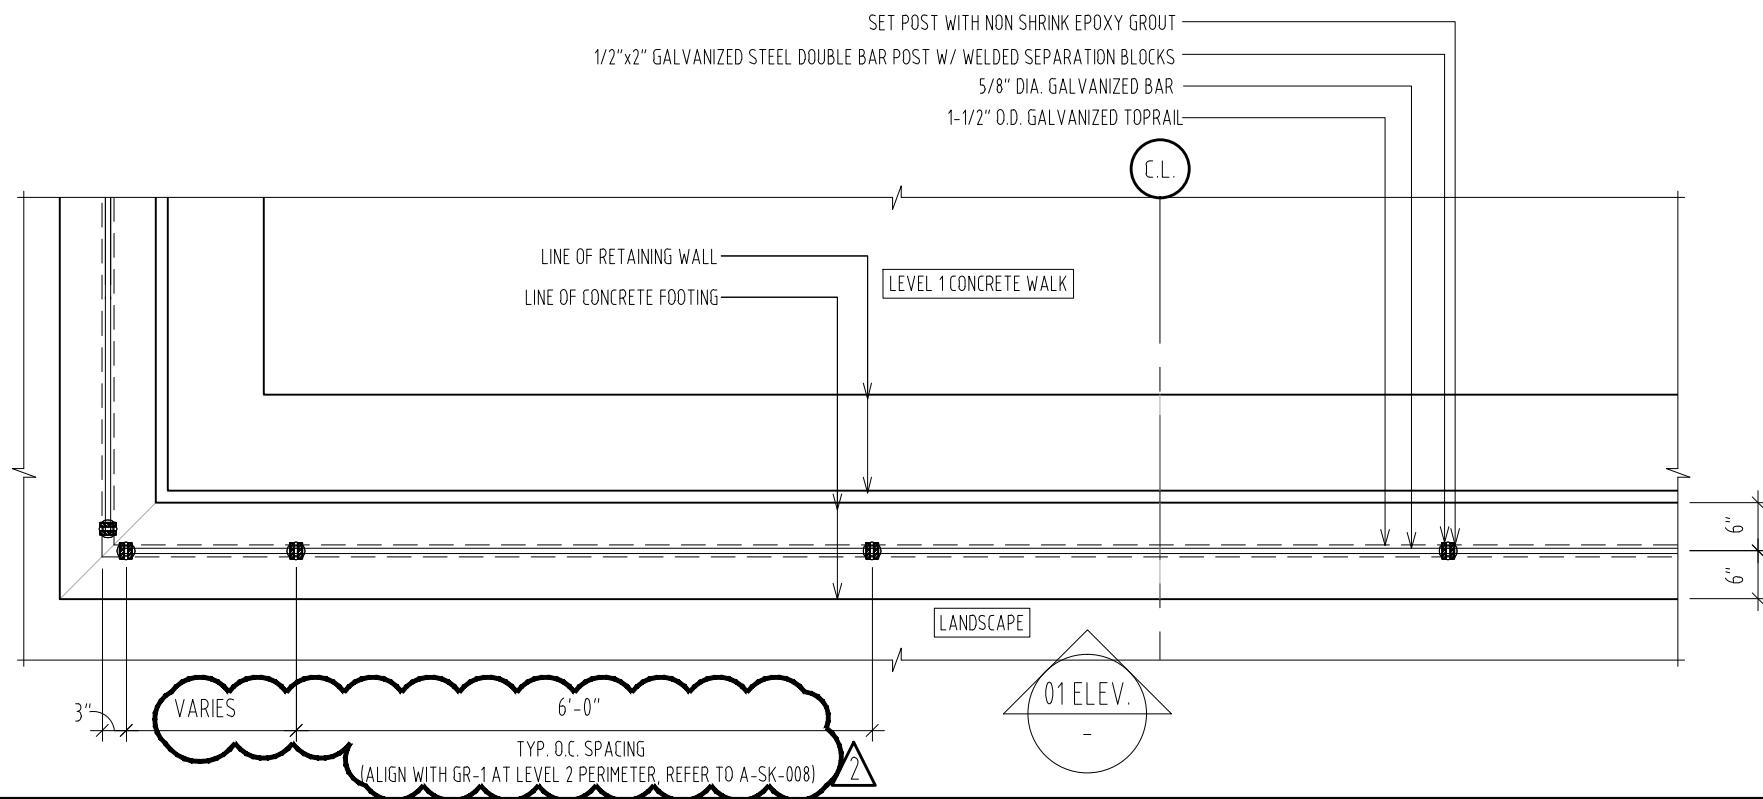

EXTERIOR GUARDRAIL AT RETAINING WALL - GR-4 - PLAN
SCALE 1/2" = 1'-0"

02

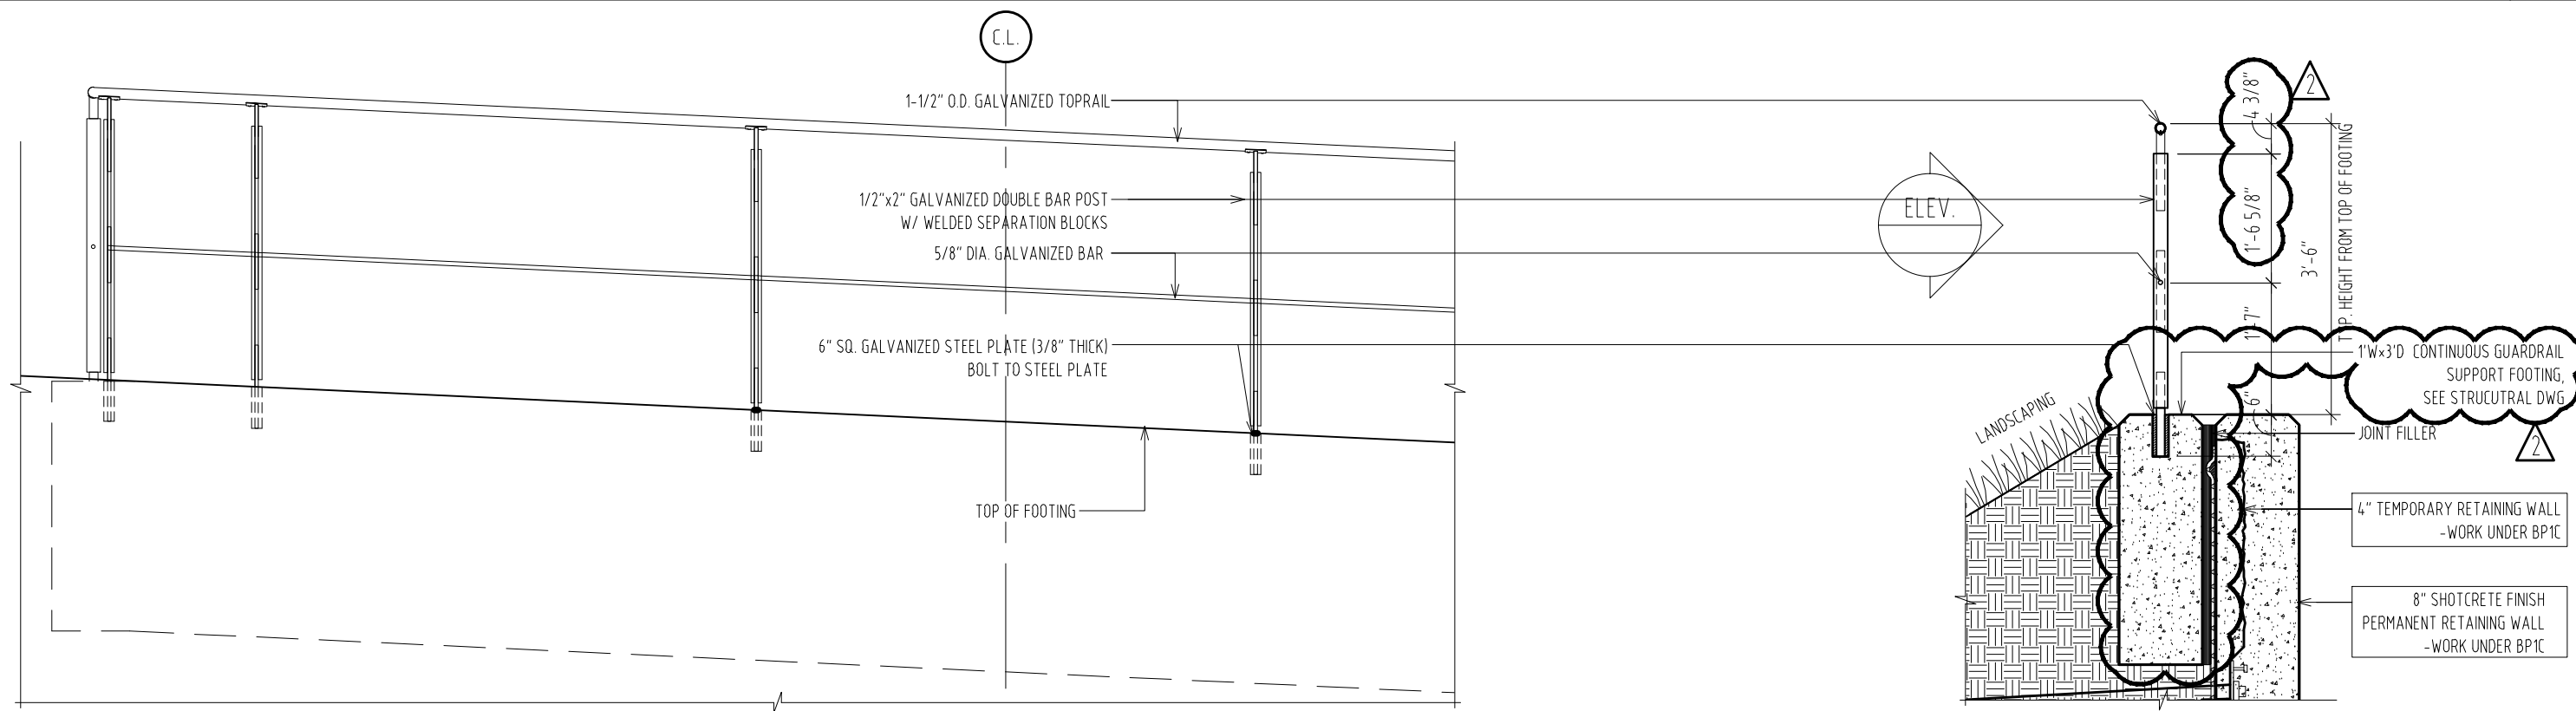

EXTERIOR GUARDRAIL AT RETAINING WALL - GR-4 - SECTION & ELEVATION
SCALE 1/2" = 1'-0"

01

MOORE SCHOOL OF BUSINESS
UNIVERSITY OF SOUTH CAROLINA
BID PACKAGE 3
ENCLOSURE/SITE/MEFP/INTERIOR
ADDENDUM #003

2012.06.22
RAFAEL VINOLY ARCHITECTS PC


ENLARGED SECTION, ELEVATION, AND PLAN - EXTERIOR GUARDRAIL GR-4 AT RETAINING WALL
REF. DWG # A4805 & A4805.1

SHEET TITLE :


SCALE :
1/2" = 1'-0"

SHEET NUMBER :
A-SK-074


PROJECT NO. 655.000

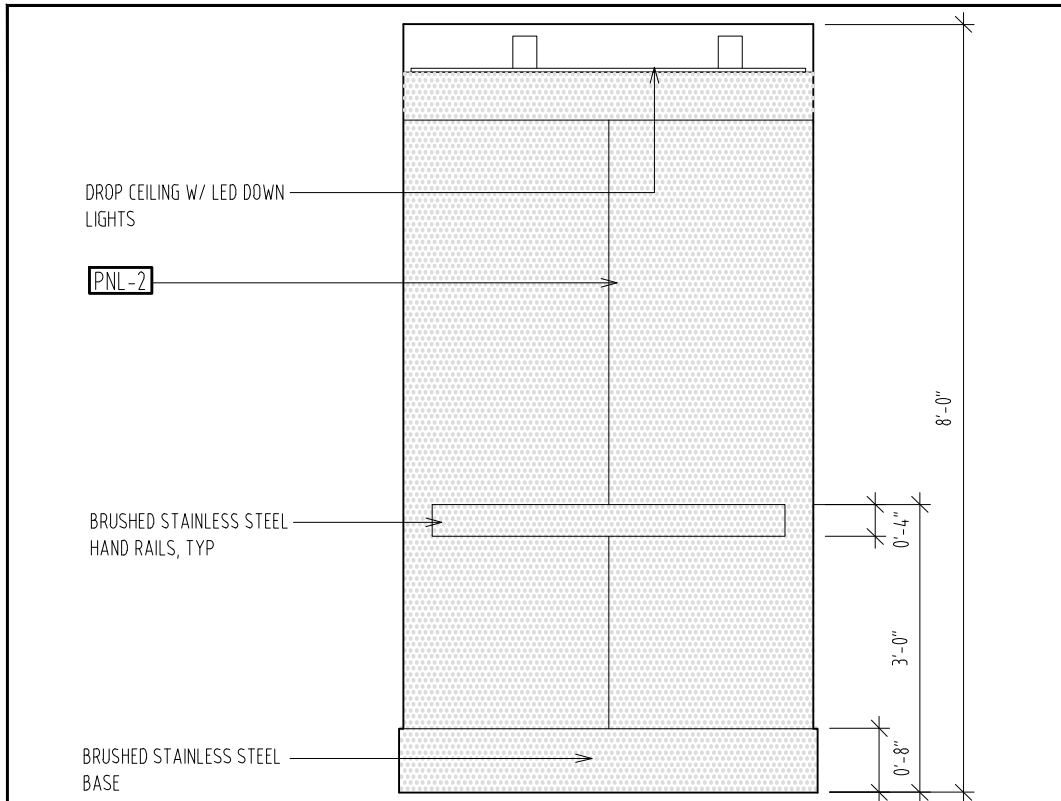


SITE ELEVATOR EV 09 CAB - ELEVATION
SCALE 1/2" = 1'-0" 05

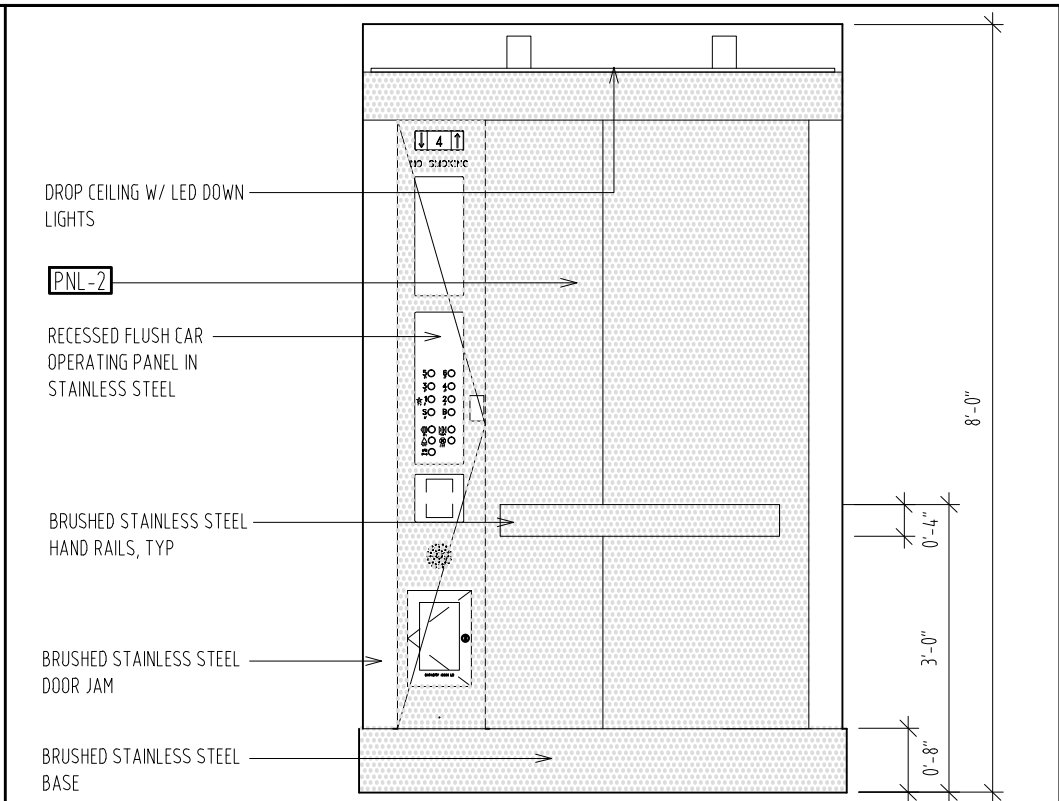


SITE ELEVATOR EV 09 CAB - ELEVATION
SCALE 1/2" = 1'-0" 04

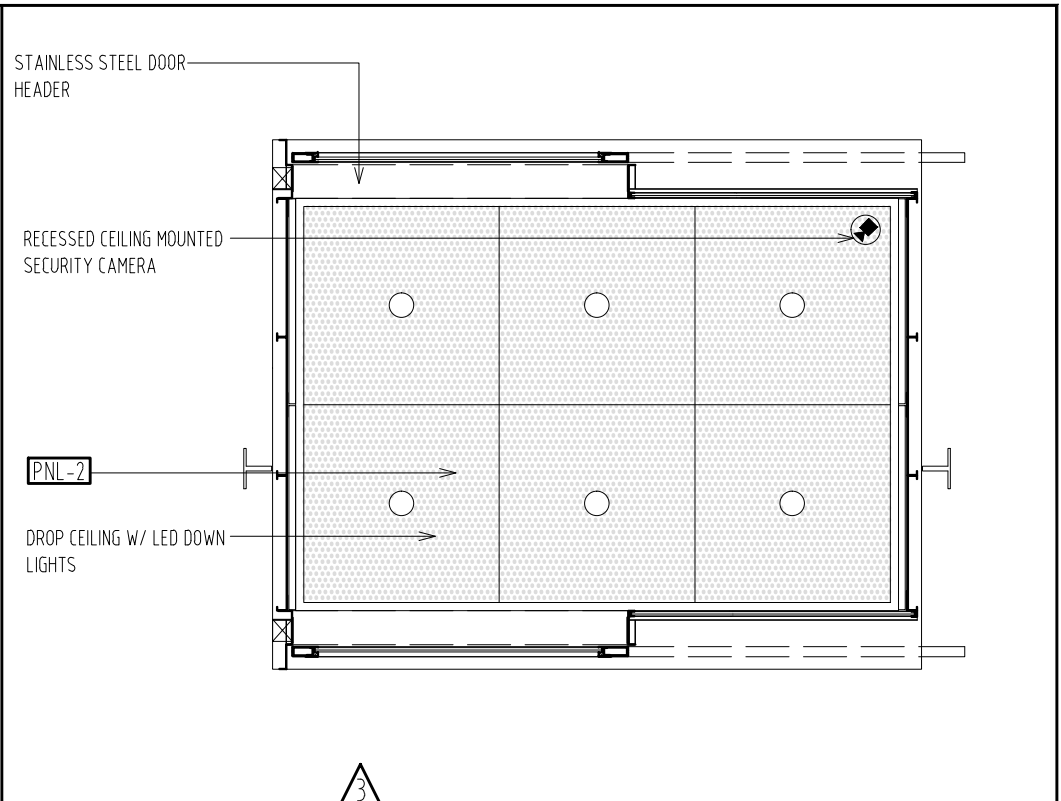

SITE ELEVATOR EV 09 CAB - REFLECTED CEILING PLAN
SCALE 1/2" = 1'-0" 02

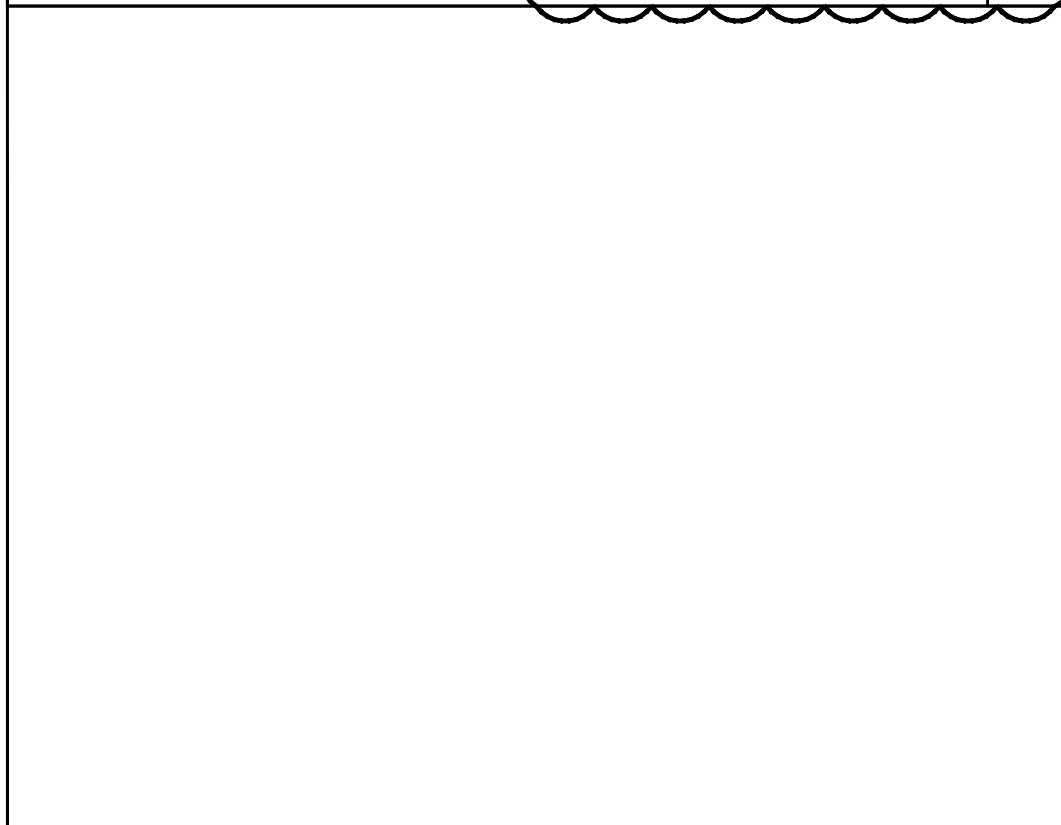


SITE ELEVATOR EV 09 CAB - FRONT & REAR ELEVATION
SCALE 1/2" = 1'-0" 03

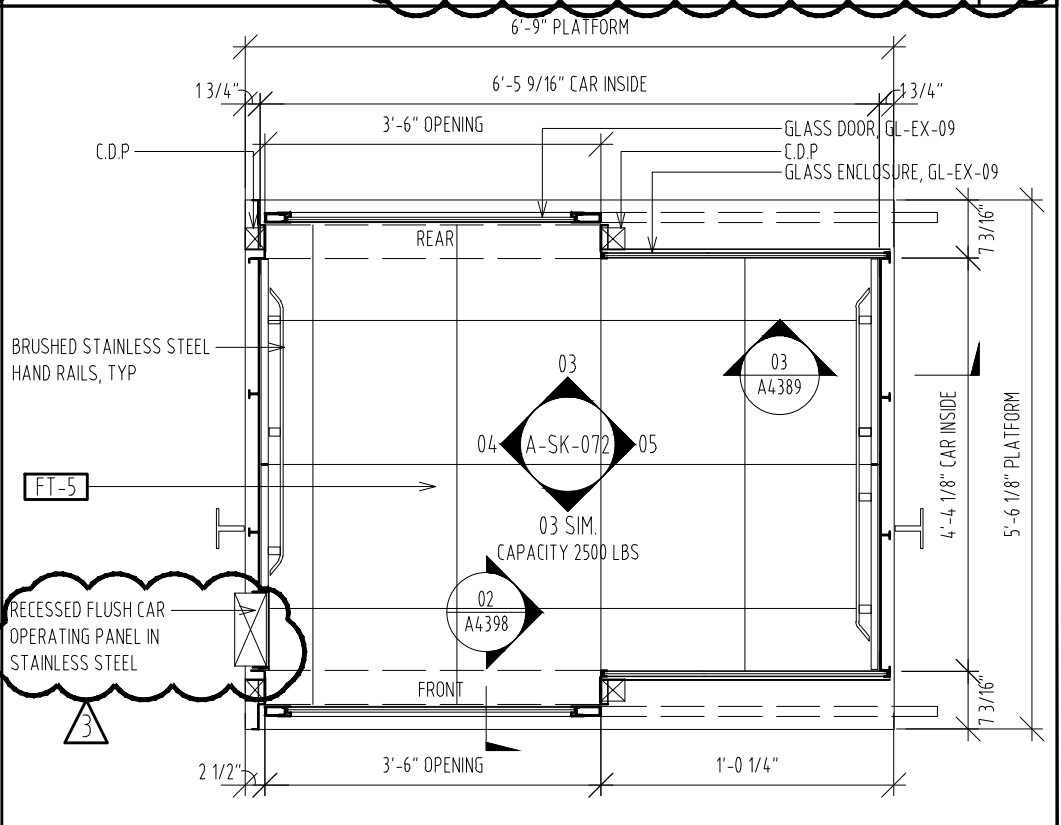


SITE ELEVATOR EV 09 CAB - PLAN
SCALE 1/2" = 1'-0" 01


GENERAL NOTE:
 1) REFER TO A1230 SERIES FOR LOCATION OF FLAG POLE

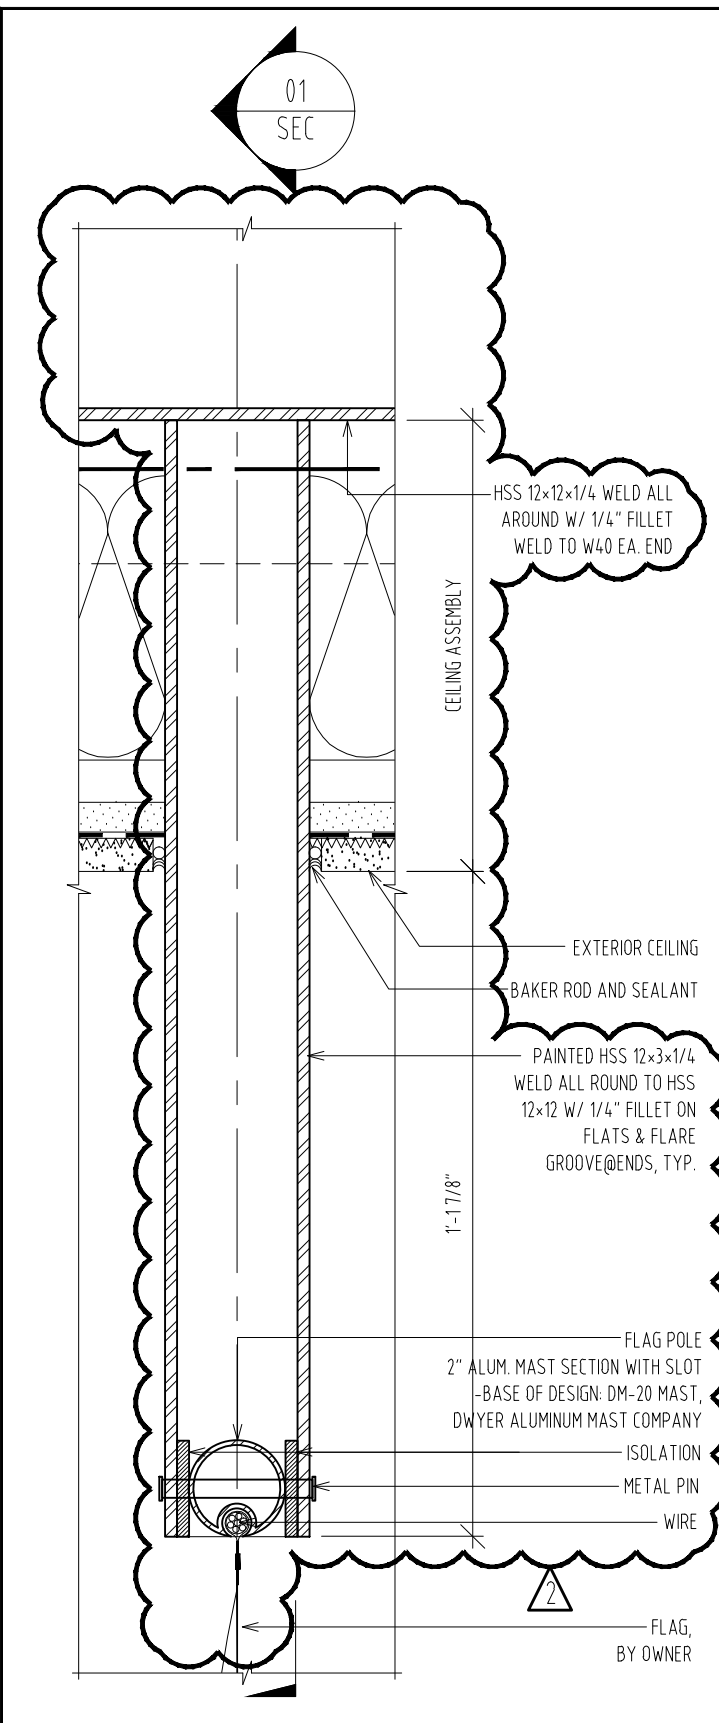

SECTION 01
 SCALE 3" = 1'-0"

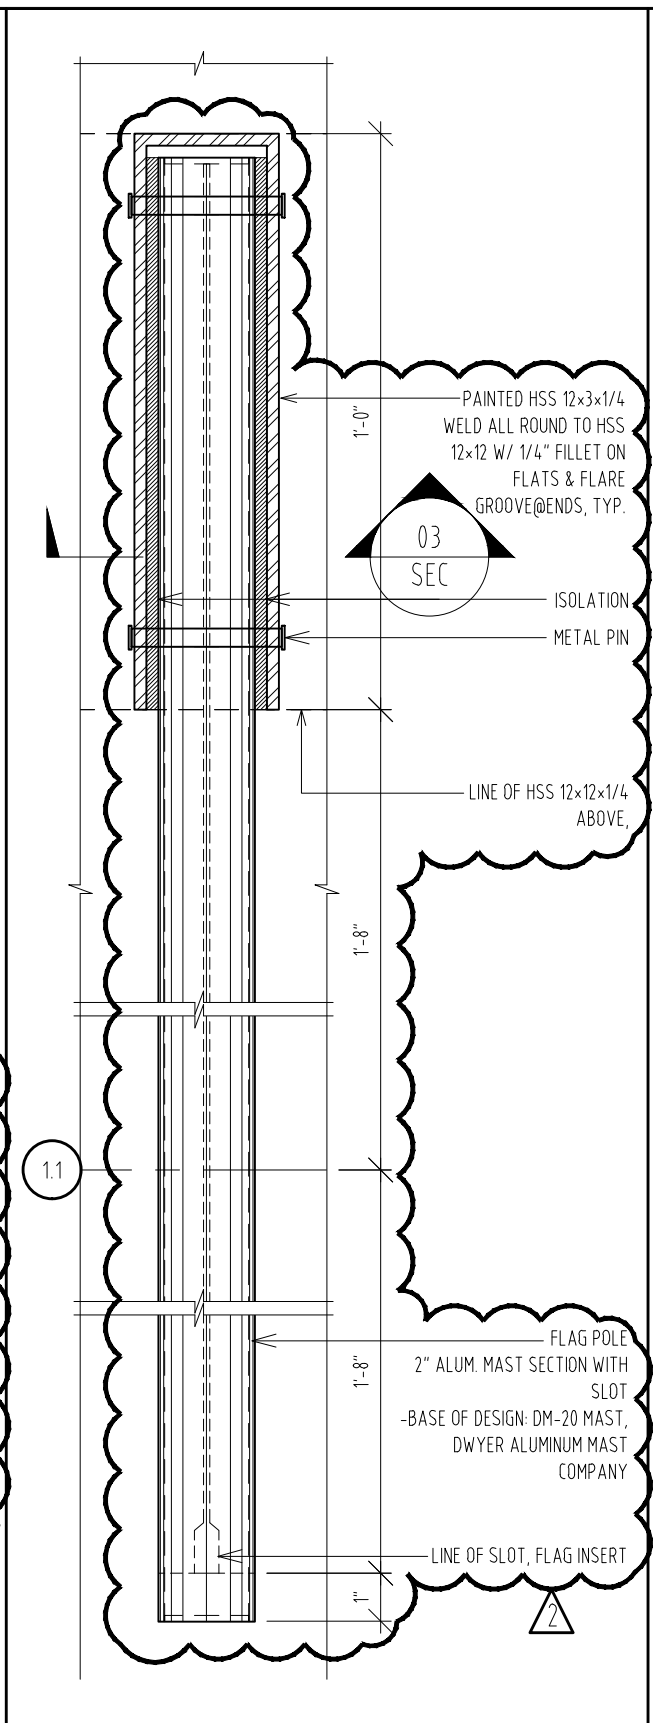

SECTION 02
 SCALE 3" = 1'-0"

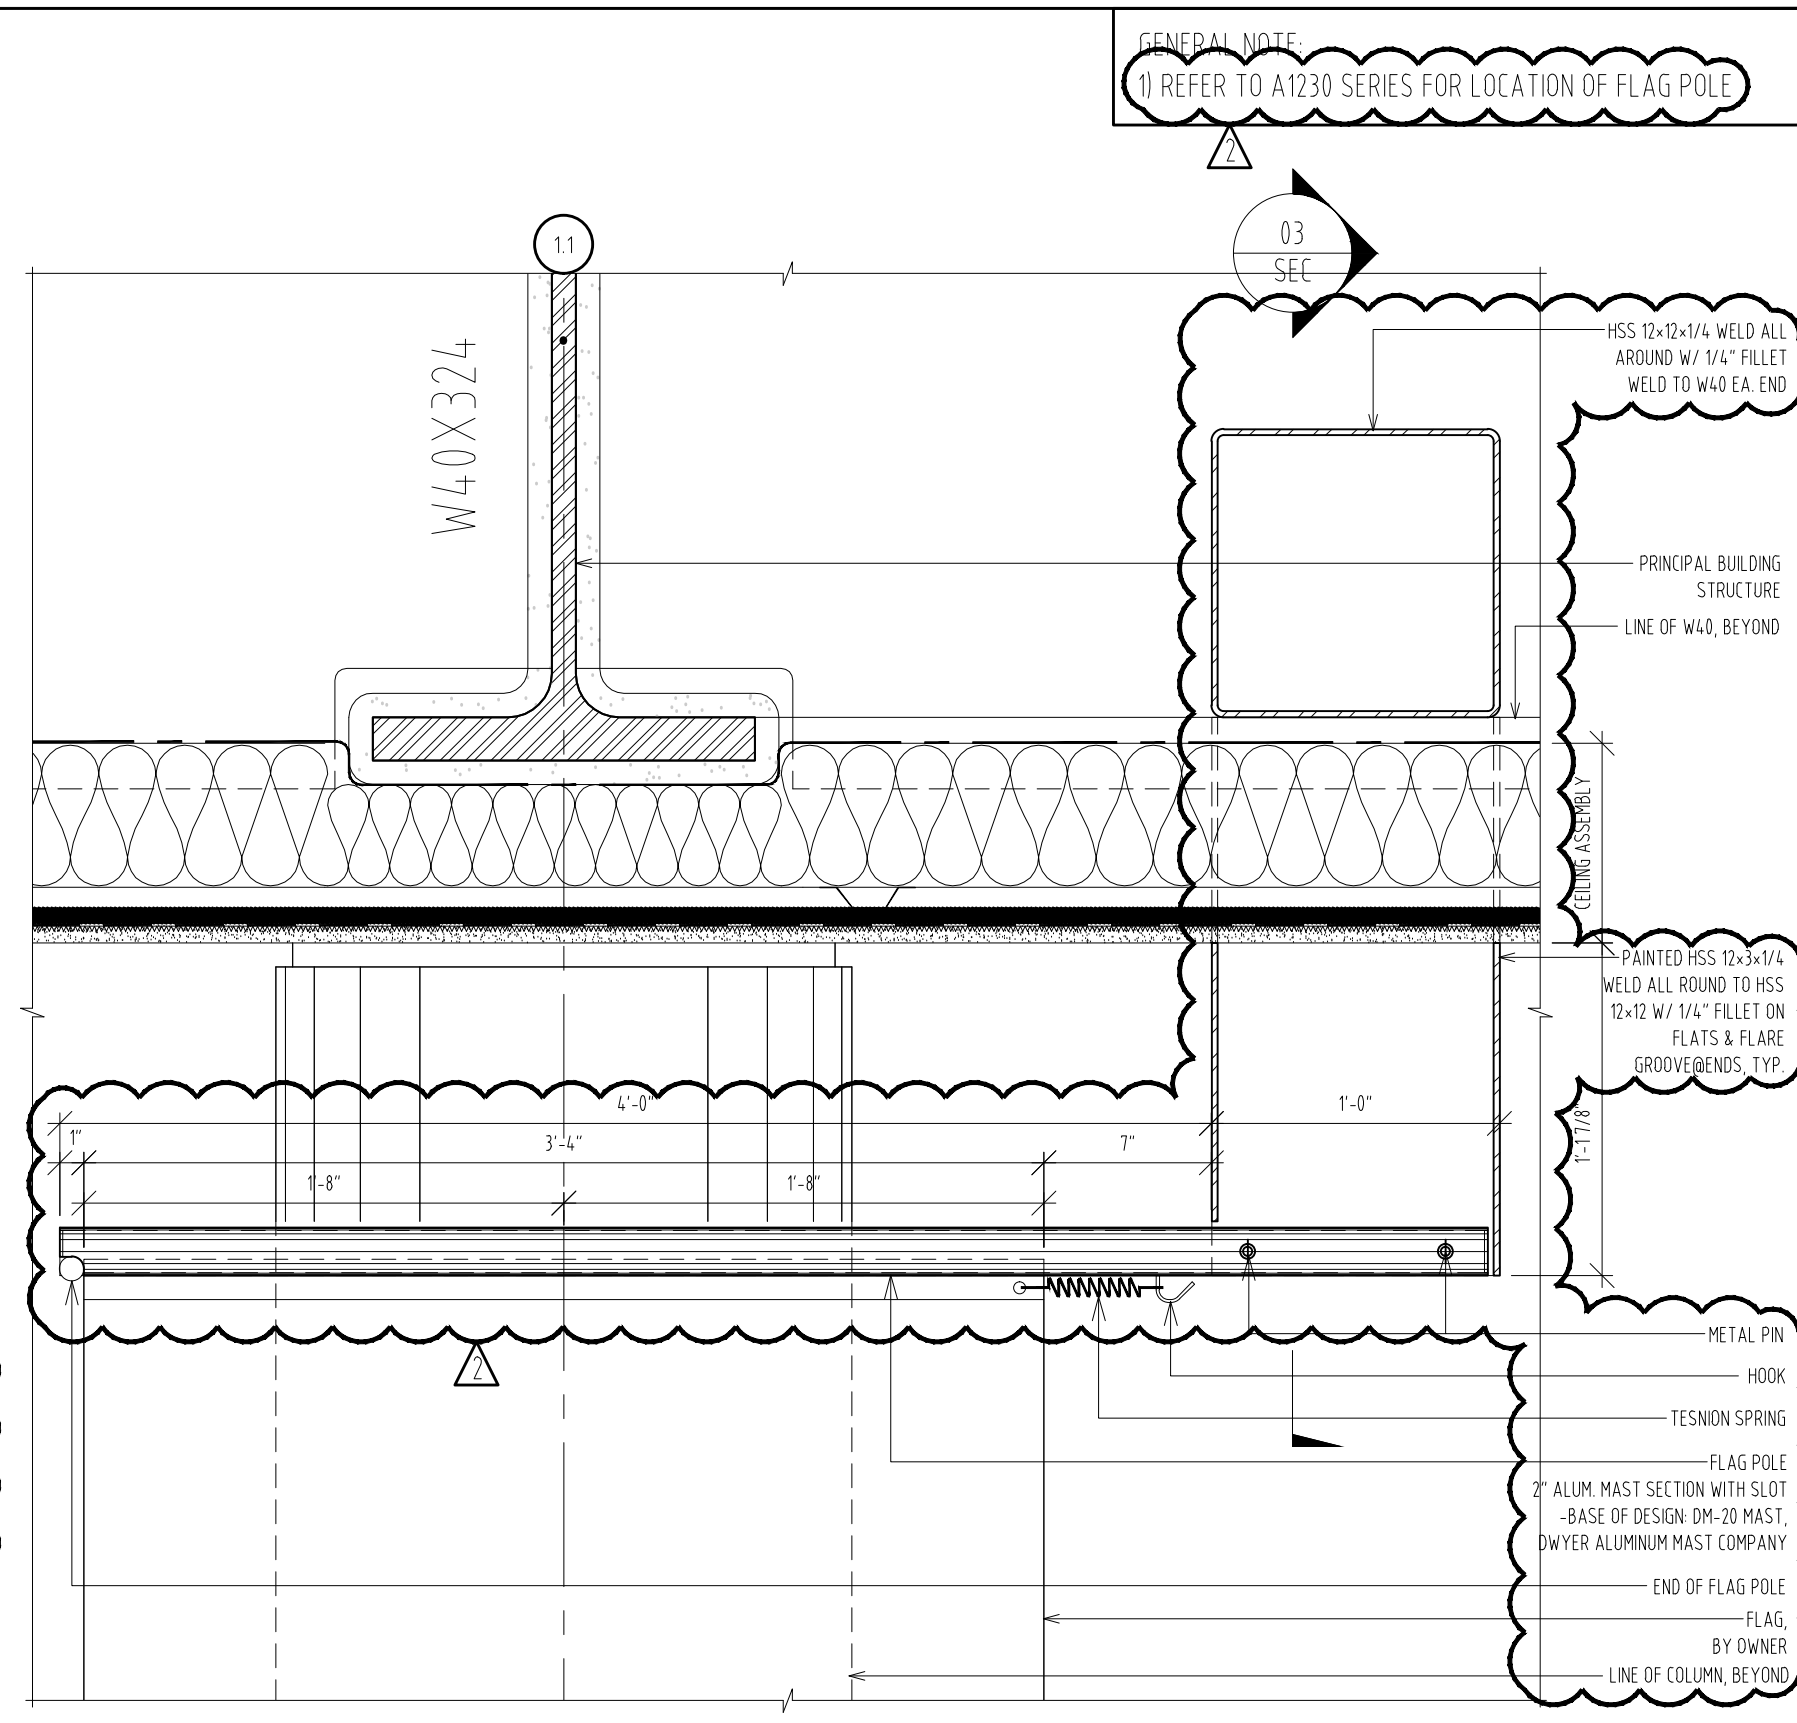

SECTION 03
 SCALE 1 1/2" = 1'-0"

MOORE SCHOOL OF BUSINESS
 UNIVERSITY OF SOUTH CAROLINA
 BID PACKAGE 3
 ENCLOSURE/SITE/MEFP/INTERIOR
 ADDENDUM #003
 PROJECT NO. 655.000

2012.06.22
 RAFAEL VINOLY ARCHITECTS PC

DETAIL - FLAG POLE & FLAG POLE SUPPORT
 REF. DWG # A4850
 SHEET TITLE :

SCALE :
 VARIES
 SHEET NUMBER :
 A-SK-076

USC - DARLA MOORE SCHOOL OF BUSINESS - SCHEDULE OF DOORS - 2012.06.22

LOCATION		DOOR							FRAME			NOTES							
ROOM	ROOM_NAME	OPENING	TYPE A8211.2	WIDTH	HEIGHT	THICKNESS	MAT.	FINISH	TYPE A8211	MAT	FINISH	JAMB A8221	HEAD A8222	SILL A8223	STC & GASKETING	FIRE RATING	HARDWRE SET#	ACCESS CONTROLS	NOTES
LEVEL 0 DOORS																			
004	LOADING DOCK	004.A	E1	18'-11"	14'-6"	PER SPEC.	STL	PTD	EXTERIOR	STL	PTD	-	-	-	-	-	2.0	DP	-
006	REFUSE ROOM	006.A	E1	18'-10"	14'-6"	PER SPEC.	STL	PTD	EXTERIOR	STL	PTD	-	-	-	-	-	2.0	DP	-
H003	CORRIDOR	H003.A	E7	72"	96"	1 3/4"	HM	PTD	EXTERIOR	HM	PTD	-	-	-	-	-	901.100000	CR/DP	EGRESS
X001	FIRE PUMP CONTROL RM.	X001.A	E8	72"	96"	1 3/4"	HM	FF	EXTERIOR	HM	PTD	-	-	-	-	-	901.1	DP	EGRESS
LEVEL 1																			
104.000000	DISCUSSION RECITATION RM.	104.A	5.000000	36"	96"	1 3/4"	HM	PTD	F7	HM	PTD	J2	H6	S2	GA-1	-	6.3	-	EGRESS
H101	CORRIDOR	H101.A	E5	72"	96"	1 3/4"	ALUM	PTD	EXTERIOR	ALUM	PTD	-	-	-	-	45 MIN.	907.4	CR/DP	EGRESS
H104A	CORRIDOR	H104.A	E5	72"	96"	1 3/4"	ALUM	PTD	EXTERIOR	ALUM	PTD	-	-	-	-	45 MIN.	907.1	CR/DP	EGRESS
H106	CORRIDOR	H106.A	E5	72"	96"	1 3/4"	ALUM	PTD	EXTERIOR	ALUM	PTD	-	-	-	-	45 MIN.	907.4	CR/DP	EGRESS
H108	CORRIDOR	H108.A	E5	72"	96"	1 3/4"	ALUM	PTD	EXTERIOR	ALUM	PTD	-	-	-	-	45 MIN.	907.1	CR/DP	EGRESS
V101	VESTIBULE	V101.B	E5	72"	96"	1 3/4"	ALUM	PTD	EXTERIOR	ALUM	PTD	-	-	-	-	-	908.0	ADA	EGRESS
V101	VESTIBULE	V101.C	E5	72"	96"	1 3/4"	ALUM	PTD	EXTERIOR	ALUM	PTD	-	-	-	-	-	910.0	DP	EGRESS
V101	VESTIBULE	V101.D	E5	72"	96"	1 3/4"	ALUM	PTD	EXTERIOR	ALUM	PTD	-	-	-	-	-	907.900000	CR/ADA/DP	EGRESS
V102	VESTIBULE	V102.A	E5	72"	96"	1 3/4"	ALUM	PTD	EXTERIOR	ALUM	PTD	-	-	-	-	-	19.0	-	EGRESS
V102	VESTIBULE	V102.B	E5	72"	96"	1 3/4"	ALUM	PTD	EXTERIOR	ALUM	PTD	-	-	-	-	-	19.0	-	EGRESS
V102	VESTIBULE	V102.C	E5	72"	96"	1 3/4"	ALUM	PTD	EXTERIOR	ALUM	PTD	-	-	-	-	-	910.0	DP	EGRESS
V102	VESTIBULE	V102.D	E5	72"	96"	1 3/4"	ALUM	PTD	EXTERIOR	ALUM	PTD	-	-	-	-	-	910.0	DP	EGRESS
LEVEL 2																			
241	SERVERY	241.B	I3	36"	106"	1 3/4"	WD	LA-2	F1	HM	PTD	J9	H9	-	-	-	2.0	-	-
241A	CAFÉ SEATING	241A.A	E2	36"	96"	1 3/4"	ALUM	PTD	EXTERIOR	ALUM	PTD	-	-	-	-	-	911.0	DP	-
241D	DISH DROP	241D.B	I2	40"	72"	PER MANU.	STL	PTD	-	-	-	-	-	-	-	-	20.0	-	MANUAL OPERATION
241D	DISH DROP	241D.C	I2	40"	72"	PER MANU.	STL	PTD	-	-	-	-	-	-	-	-	20.0	-	MANUAL OPERATION
245	DISTRIBUTED INFORMAL LEARNING	245.A	E2	36"	96"	1 3/4"	ALUM	PTD	EXTERIOR	ALUM	PTD	-	-	-	-	-	911.0	DP	-
H203	CORRIDOR - WEST	H203.A	E2	36"	96"	1 3/4"	ALUM	PTD	EXTERIOR	ALUM	PTD	-	-	-	-	-	911.0	DP	-
H203	CORRIDOR - EAST	H203.D	E2	36"	96"	1 3/4"	ALUM	PTD	EXTERIOR	ALUM	PTD	-	-	-	-	-	911.0	DP	-
H203A	CORRIDOR	237A.A	E3	72"	96"	1 3/4"	ALUM	PTD	EXTERIOR	ALUM	PTD	-	-	-	-	-	910.1	DP	EGRESS
H203A	CORRIDOR	237D.A	E3	72"	96"	1 3/4"	ALUM	PTD	EXTERIOR	ALUM	PTD	-	-	-	-	-	907.3	CR/DP	EGRESS
H203B	CORRIDOR	H203.E	E3	72"	96"	1 3/4"	ALUM	PTD	EXTERIOR	ALUM	PTD	-	-	-	-	-	912.100000	ADA/DP	EGRESS
H203B	CORRIDOR	228.A	E3	72"	96"	1 3/4"	ALUM	PTD	EXTERIOR	ALUM	PTD	-	-	-	-	-	907.500000	CR/ADA/DP	EGRESS
H205	CORRIDOR	H205.A	E3	72"	90"	1 3/4"	ALUM	PTD	EXTERIOR	ALUM	PTD	-	-	-	-	-	907.5	ADA/CR/DP	EGRESS
H205	CORRIDOR	H205.B	E3	72"	90"	1 3/4"	ALUM	PTD	EXTERIOR	ALUM	PTD	-	-	-	-	-	908.1	ADA	EGRESS
V201	VESTIBULE	V201.A	E5	72"	104"	1 3/4"	ALUM	PTD	EXTERIOR	ALUM	PTD	-	-	-	-	-	907.5	CR/ADA/DP	EGRESS
V201	VESTIBULE	V201.B	E5	72"	104"	1 3/4"	ALUM	PTD	EXTERIOR	ALUM	PTD	-	-	-	-	-	908.1	ADA	EGRESS
V204	VESTIBULE	V204.A	E5	72"	104"	1 3/4"	ALUM	PTD	EXTERIOR	ALUM	PTD	-	-	-	-	-	908.1	ADA	EGRESS
V204	VESTIBULE	V204.B	E5	72"	104"	1 3/4"	ALUM	PTD	EXTERIOR	ALUM	PTD	-	-	-	-	-	907.5	CR/ADA/DP	EGRESS
LEVEL 3																			
332	EXEC. EDU. STAFF	332.A	1	36"	96"	1 3/4"	HM.	PTD	F4	HM	PTD	J4	H4	-	-	-	10.0	-	EGRESS
339	BPF DIRECTOR	339.A	1.000000	36"	96"	1 3/4"	HM.	PTD	F8	HM	PTD	J1	H6	-	-	-	10.1	-	-
354A	DEAN'S RESTROOM	354A.A	1.000000	36"	96"	1 3/4"	WD	FF	F1	HM	PTD	J1	H1	S2	-	-	11200000	-	-
354B	TERRACE	354B.A	E10	130"	111"	1.75"	ALUM	PTD	EXTERIOR	ALUM	PTD	-	-	-	-	-	2.0	-	AS PER MANUFACTURER
354B	TERRACE	354B.B	E9	82"	111"	1.75"	ALUM	PTD	EXTERIOR	ALUM	PTD	-	-	-	-	-	2.0	-	AS PER MANUFACTURER
354B	TERRACE	354B.C	E9	82"	111"	1.75"	ALUM	PTD	EXTERIOR	ALUM	PTD	-	-	-	-	-	2.0	-	AS PER MANUFACTURER
V301	VESTIBULE	V301.A	E5	36"	96"	1.75"	ALUM	PTD	EXTERIOR	ALUM	PTD	-	-	-	-	-	907.1	CR/DP	-
V301	VESTIBULE	V301.B	E5	36"	96"	1.75"	ALUM	PTD	EXTERIOR	ALUM	PTD	-	-	-	-	-	8.4	-	-
V302	STAIR VESTIBULE	V302.A	E5	72"	96"	1.75"	ALUM	PTD	EXTERIOR	ALUM	PTD	-	-	-	-	-	8.4	-	-
V302	STAIR VESTIBULE	V302.B	E5	72"	96"	1.75"	ALUM	PTD	EXTERIOR	ALUM	PTD	-	-	-	-	-	907.1	CR/DP	-
LEVEL 4																			
V401	VESTIBULE	V401.A	E5	72"	96"	1 3/4"	ALUM	PTD	EXTERIOR	ALUM	PTD	-	-	-	-	-	19.0	-	EGRESS
V401	VESTIBULE	V401.B	E5	72"	96"	1 3/4"	ALUM	PTD	EXTERIOR	ALUM	PTD	-	-	-	-	-	913.2	CR/DP	EGRESS
V402	VESTIBULE	V402.A	E5	72"	96"	1 3/4"	ALUM	PTD	EXTERIOR	ALUM	PTD	-	-	-	-	-	913.0	ADA/CR	EGRESS
V402	VESTIBULE	V402.B	E4	36"	82"	1 3/4"	ALUM	PTD	EXTERIOR	ALUM	PTD	-	-	-	-	-	908.200000	ADA/DP	EGRESS
V403	VESTIBULE	V403.A	E5	72"	96"	1 3/4"	ALUM	PTD	EXTERIOR	ALUM	PTD	-	-	-	-	-	913.2	CR/DP	-
V403	VESTIBULE	V403.B	E5	72"	96"	1 3/4"	ALUM	PTD	EXTERIOR	ALUM	PTD	-	-	-	-	-	908.0	ADA	-
V403	VESTIBULE	V403.C	E4	72"	82"	1 3/4"	ALUM	PTD	EXTERIOR	ALUM	PTD	-	-	-	-	-	913.1	ADA/CR/DP	-
LEVEL 5																			
510	ALTERNATE 1 - PAVILIONS DISTR. INFORMAL LEARNING/STUDY	510.A	E3	72"	96"	1 3/4"	HM	PTD	EXTERIOR	HM	PTD	-	-	-	-	-	914.0	CR/DP	EGRESS
505	JANITOR'S ROOM	505.A	6	72"	96"	1 3/4"	HM	PTD	F1	HM	PTD	J1	H1	-	-	-	3.0	-	-
510	DISTR. INFORMAL LEARNING/STUDY	510.B	E3	72"	96"	1 3/4"	HM	PTD	EXTERIOR	HM	PTD	-	-	-	-	-	914.0	CR/DP	EGRESS
510	DISTR. INFORMAL LEARNING/STUDY	510.C	E3	72"	96"	1 3/4"	HM	PTD	EXTERIOR	HM	PTD	-	-	-	-	-	914.0	CR/DP	EGRESS
4010	SMALL MEETING RM	4010.A	11	36"	96"	1 3/4"	ALUM	PTD	F1	ALUM	PTD	J8	H8	-	-	-	21.1	-	-

ADDED

REMOVED


ADDED

ADDED

ADDED

NOTE: SHADED AREA INDICATES REVISION OF DOOR SCHEDULE.


MOORE SCHOOL OF BUSINESS
UNIVERSITY OF SOUTH CAROLINA
BID PACKAGE 3
ENCLOSURE/SITE/MEPFP/INTERIOR
ADDENDUM #003
PROJECT NO. 655.000

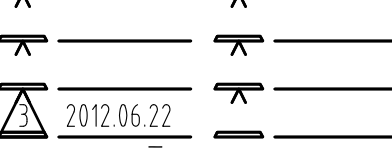
2012.06.22
RAFAEL VĀNOLY ARCHITECTS PC

REVISION - DOOR SCHEDULE
REF. DWG # A8201, A8202, A8203, A8204


SHEET TITLE:

SCALE :
NTS
SHEET NUMBER :
A-SK-077

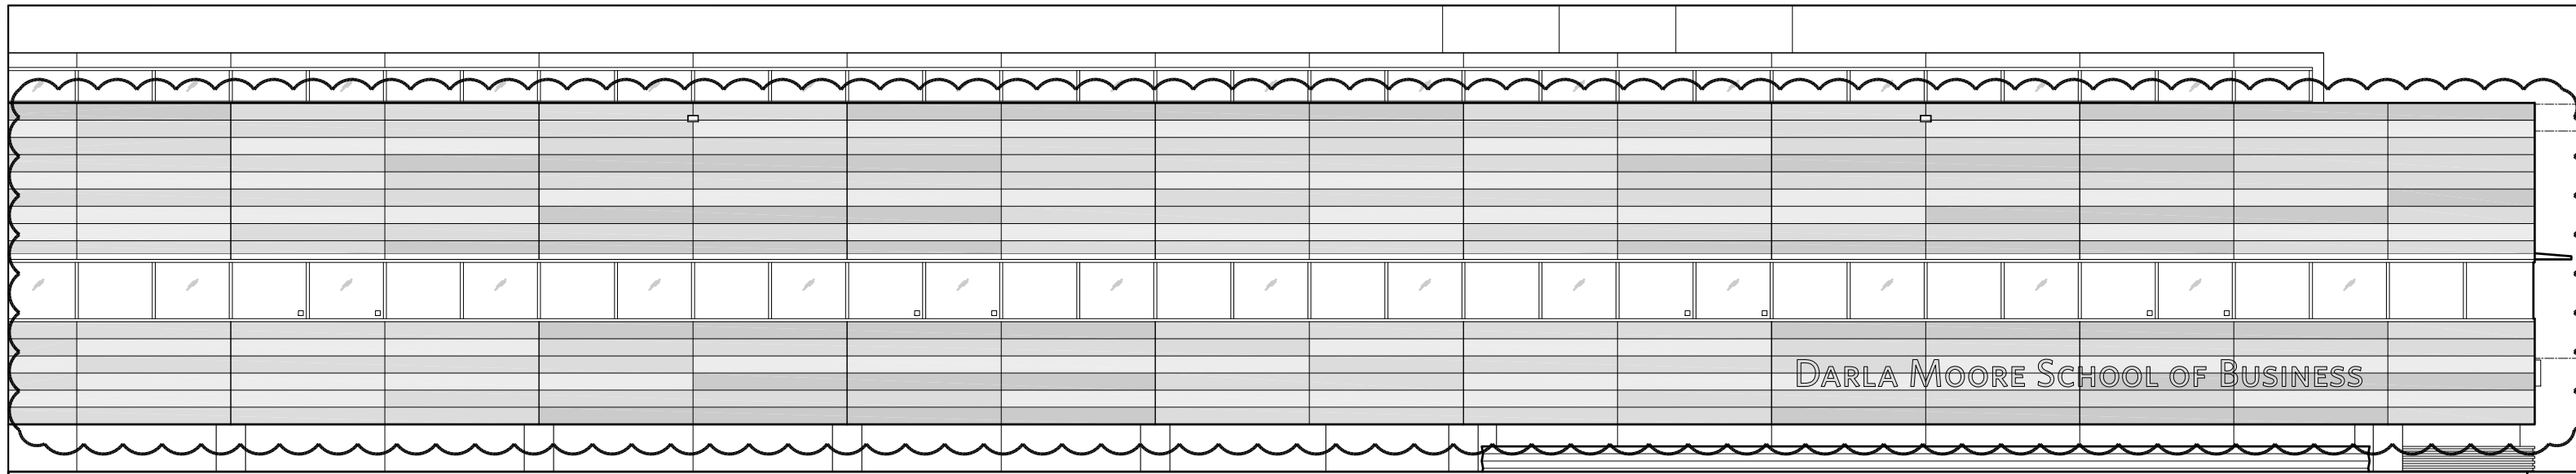

LEVEL 4 ELEVATION - NORTHWEST
SCALE 3/32" = 1'-0"


02

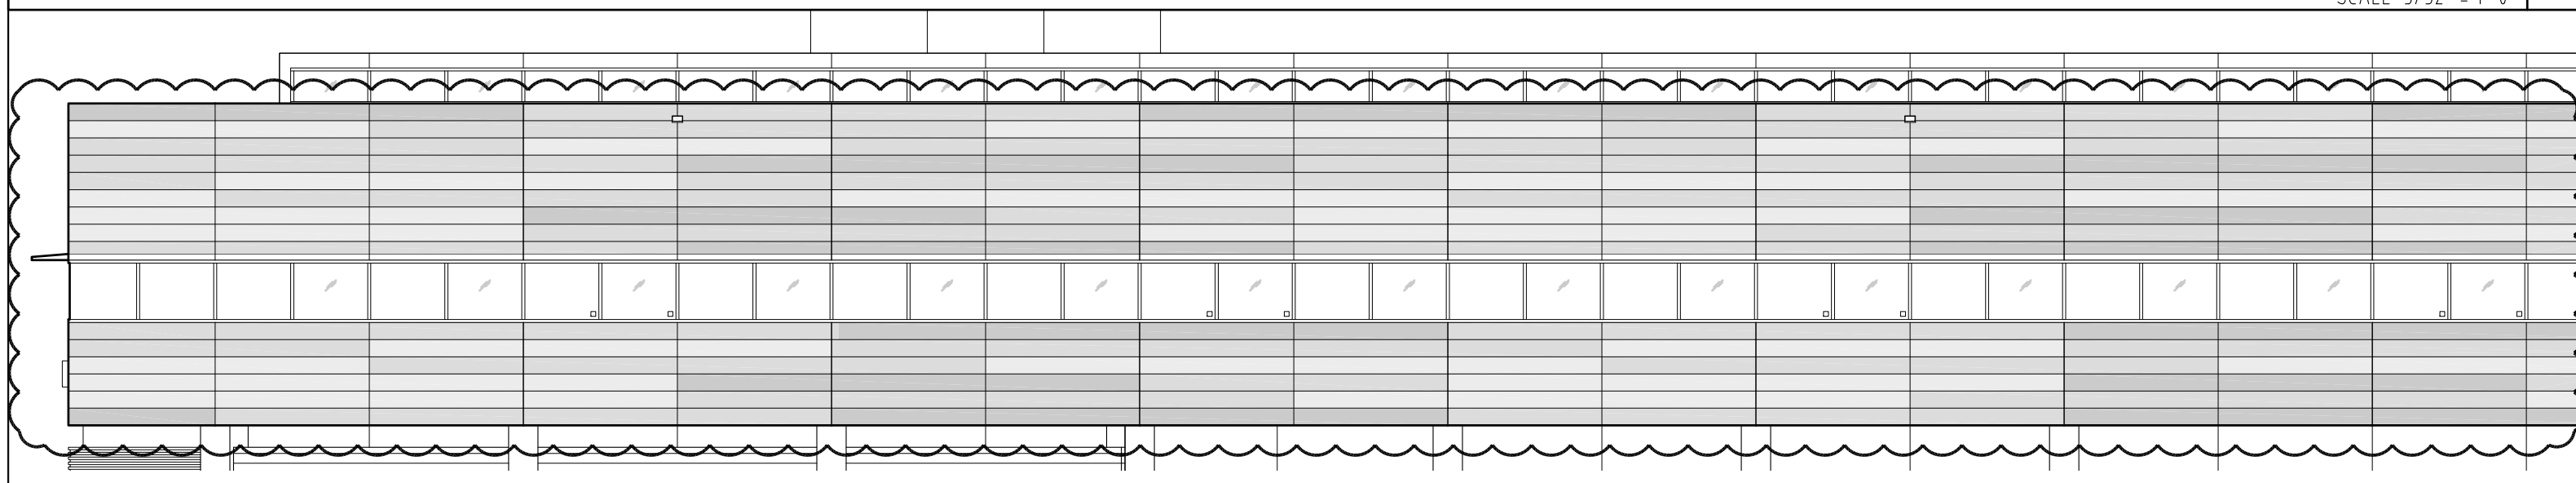

LEVEL 4 ELEVATION - NORTHEAST
SCALE 3/32" = 1'-0"

01

KEYPLAN:

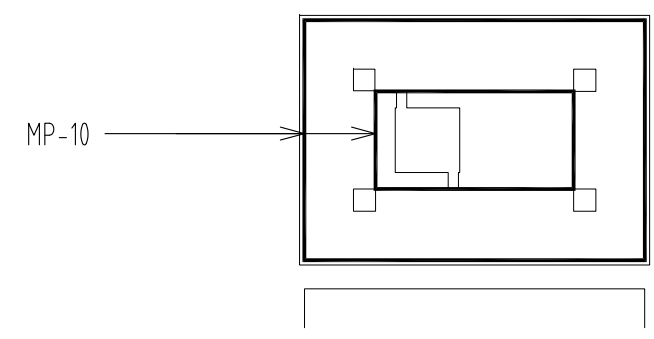

LEGEND:

- COLOR 65%
- COLOR 25%
- COLOR 15%


NOTE: MP-10 COLORS TO BE
RANDOMLY PLACED AS DIRECTED
BY ARCHITECT.

MOORE SCHOOL OF BUSINESS
UNIVERSITY OF SOUTH CAROLINA
BID PACKAGE 3
ENCLOSURE/SITE/MEPFP/INTERIOR
ADDENDUM #003
PROJECT NO. 655.000

^ ——— ^
K ——— K
3 2012.06.22
© RAFAEL VINOLY ARCHITECTS PC

L4 METAL PANEL (MP-10) COLOR DISTRIBUTION SAMPLE - NORTH FACADE
REF DWG A2101, A2102, A2103, A2104, A2201, A2211, A2221, A2222, A2231, A2232, A2241, A2251
SHEET TITLE :

SCALE :
3/32" = 1'-0"
SHEET NUMBER :
A-SK-078

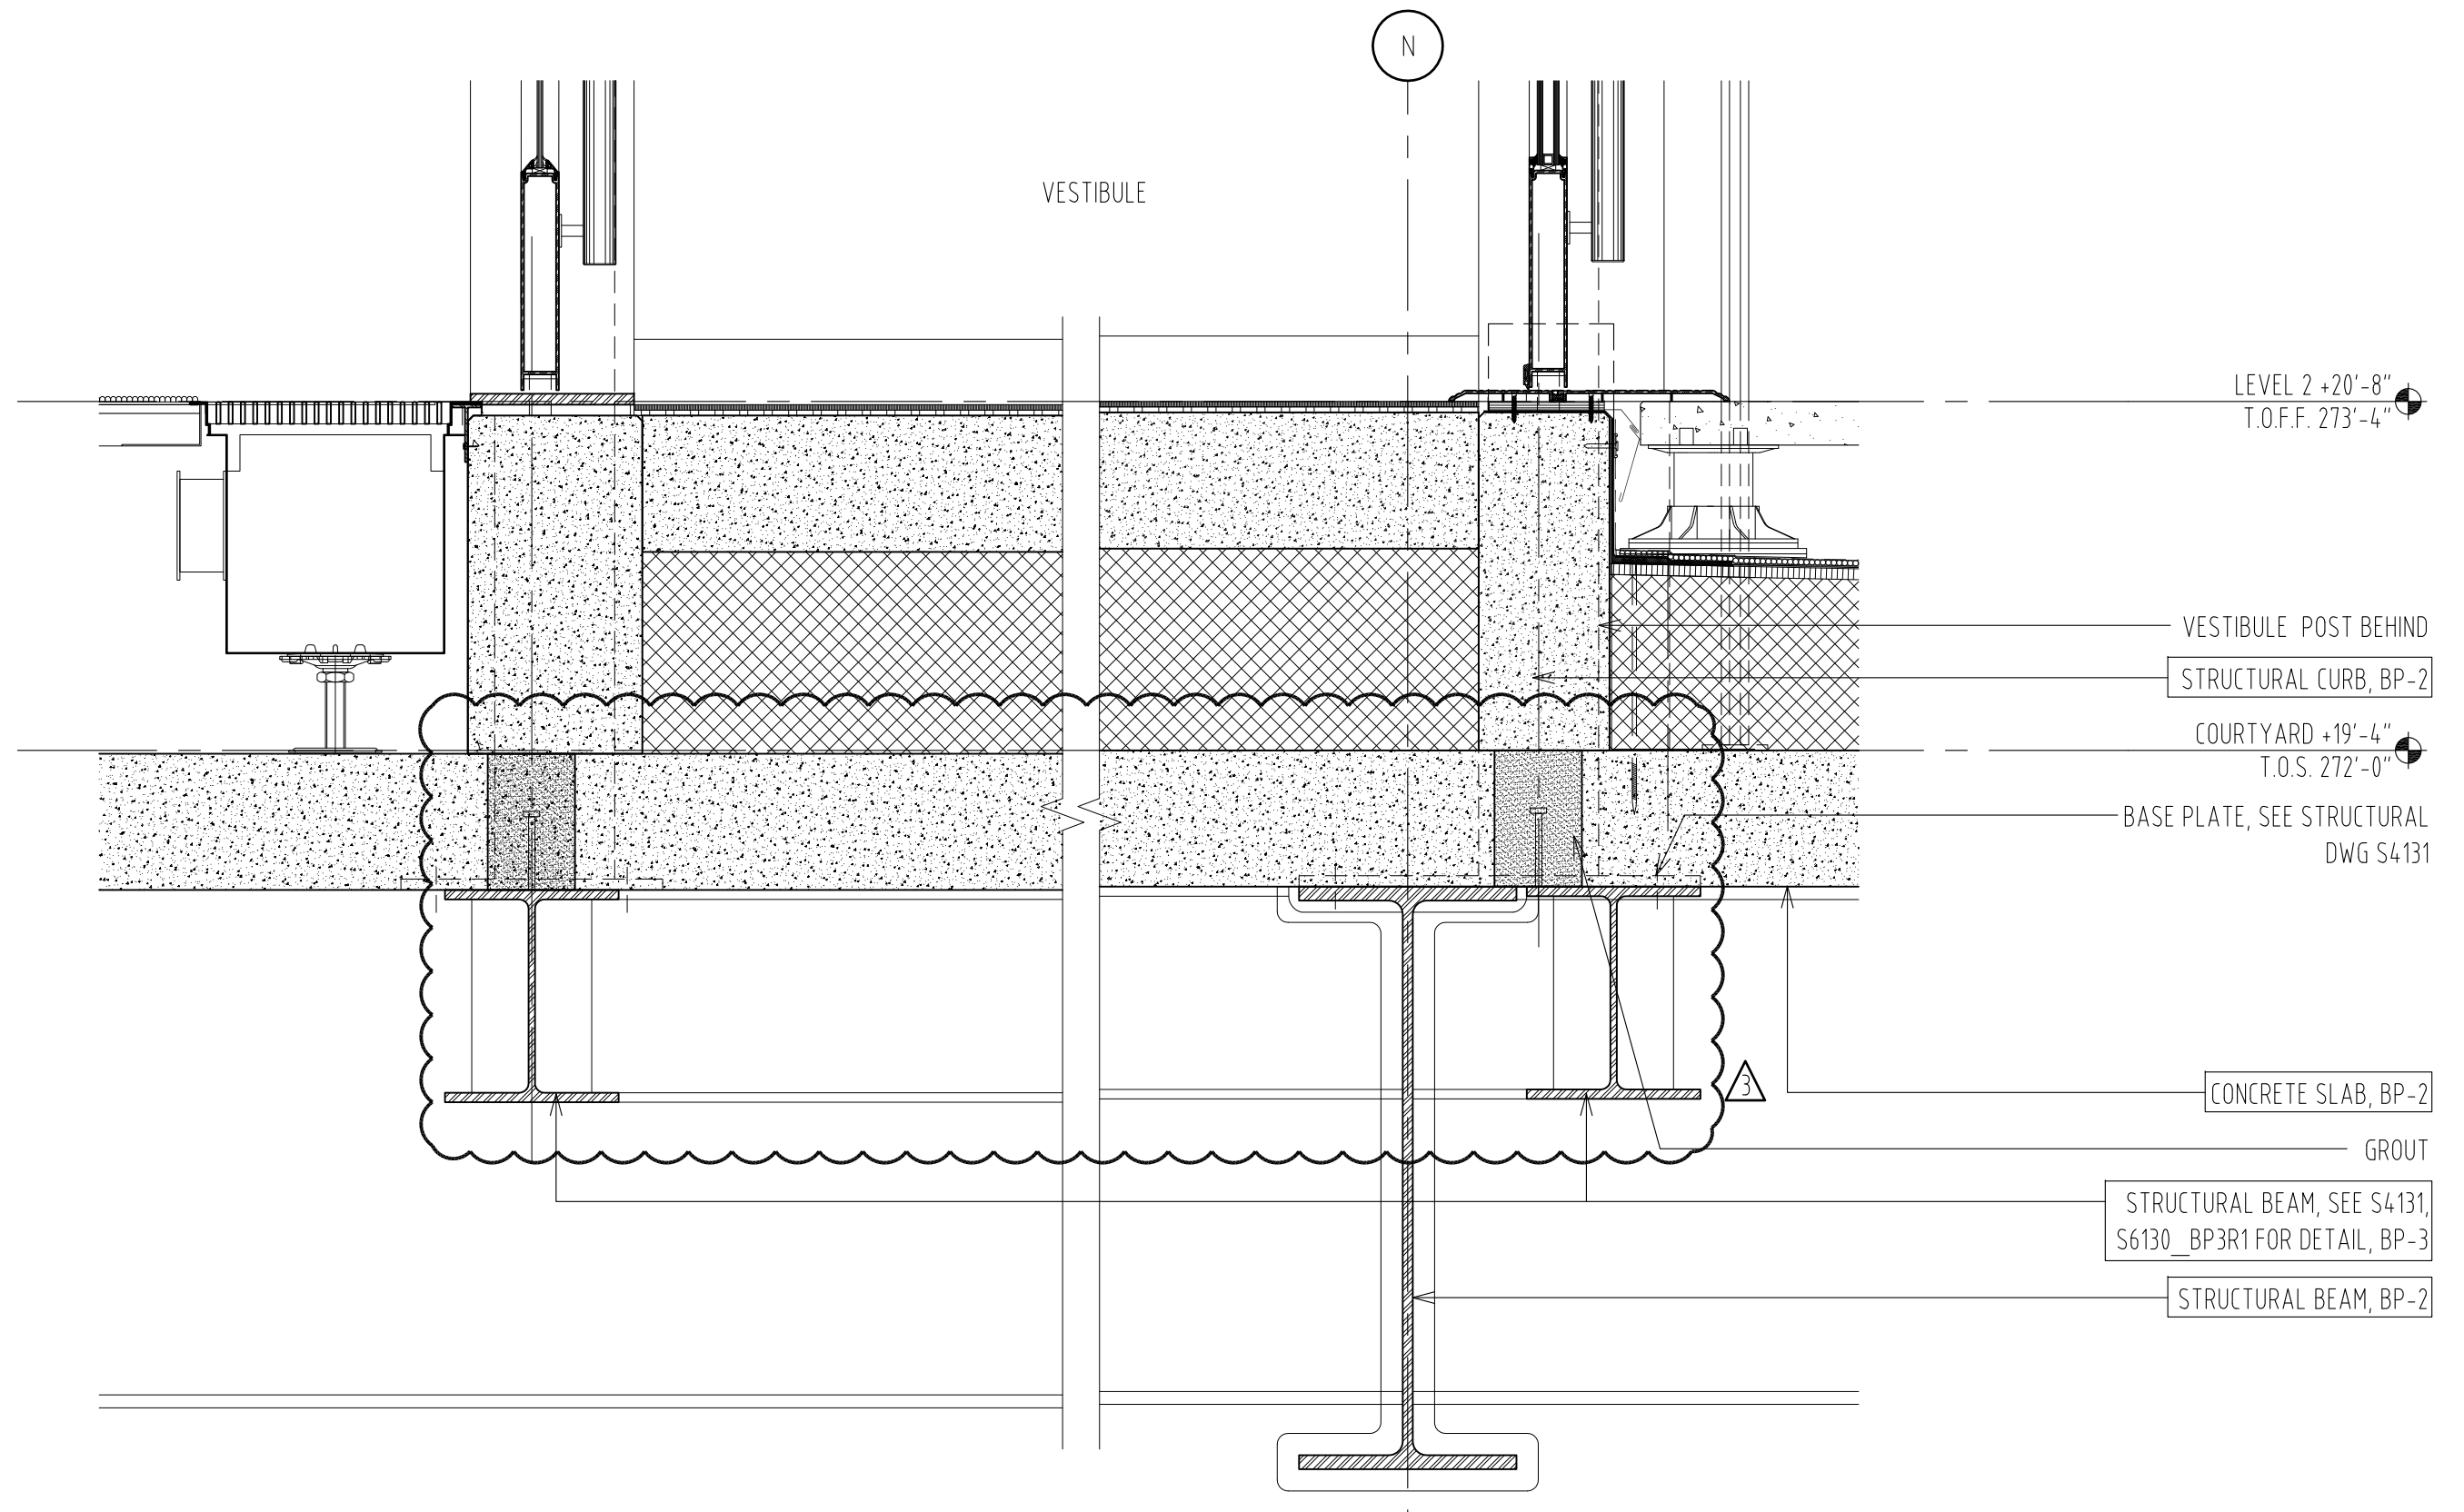

EWS-2.1: DETAIL

SCALE : 1 1/2" = 1'-0"

01

MOORE SCHOOL OF BUSINESS
UNIVERSITY OF SOUTH CAROLINA
BID PACKAGE 3
ENCLOSURE/SITE/MEPFP/INTERIOR
ADDENDUM #003


PROJECT NO. 655.000

2012.06.22
 © RAFAEL VINOLY ARCHITECTS PC

LEVEL 2 VESTIBULE - NEW BEAM UNDER EXISTING SLAB
REF. DWG # A4621.3, (A4621.4 SIMILAR), A4621.13

SHEET TITLE :


SCALE :
1 1/2" = 1'-0"
SHEET NUMBER :
A-SK-079

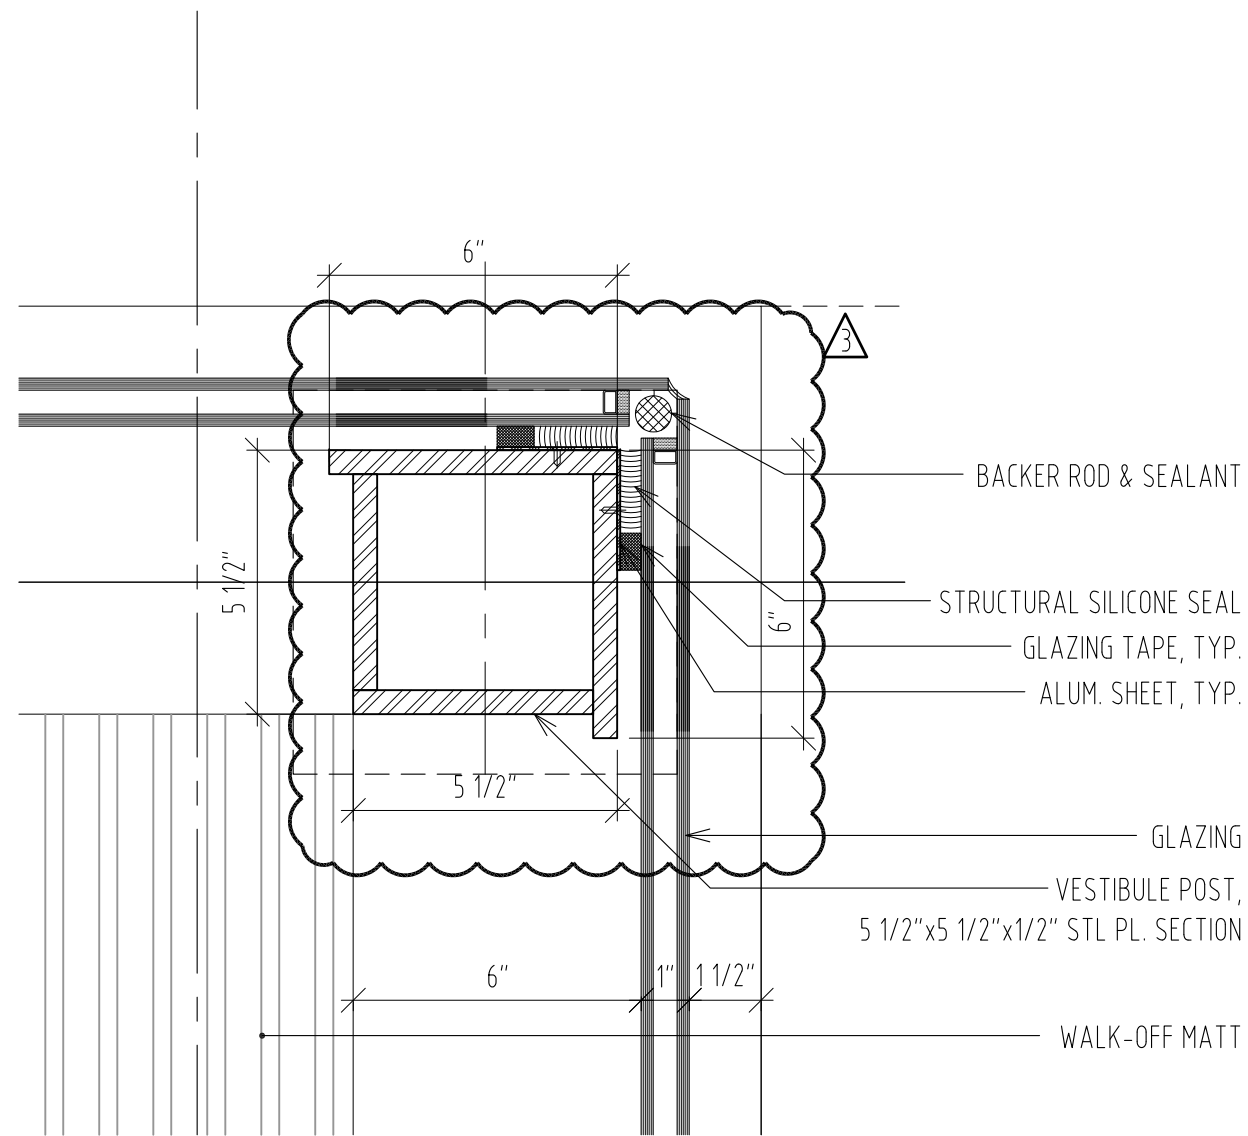

REF. DWG #03/A4621.5

EWS-2.1: DETAIL
SCALE : 3"=1'-0"

02

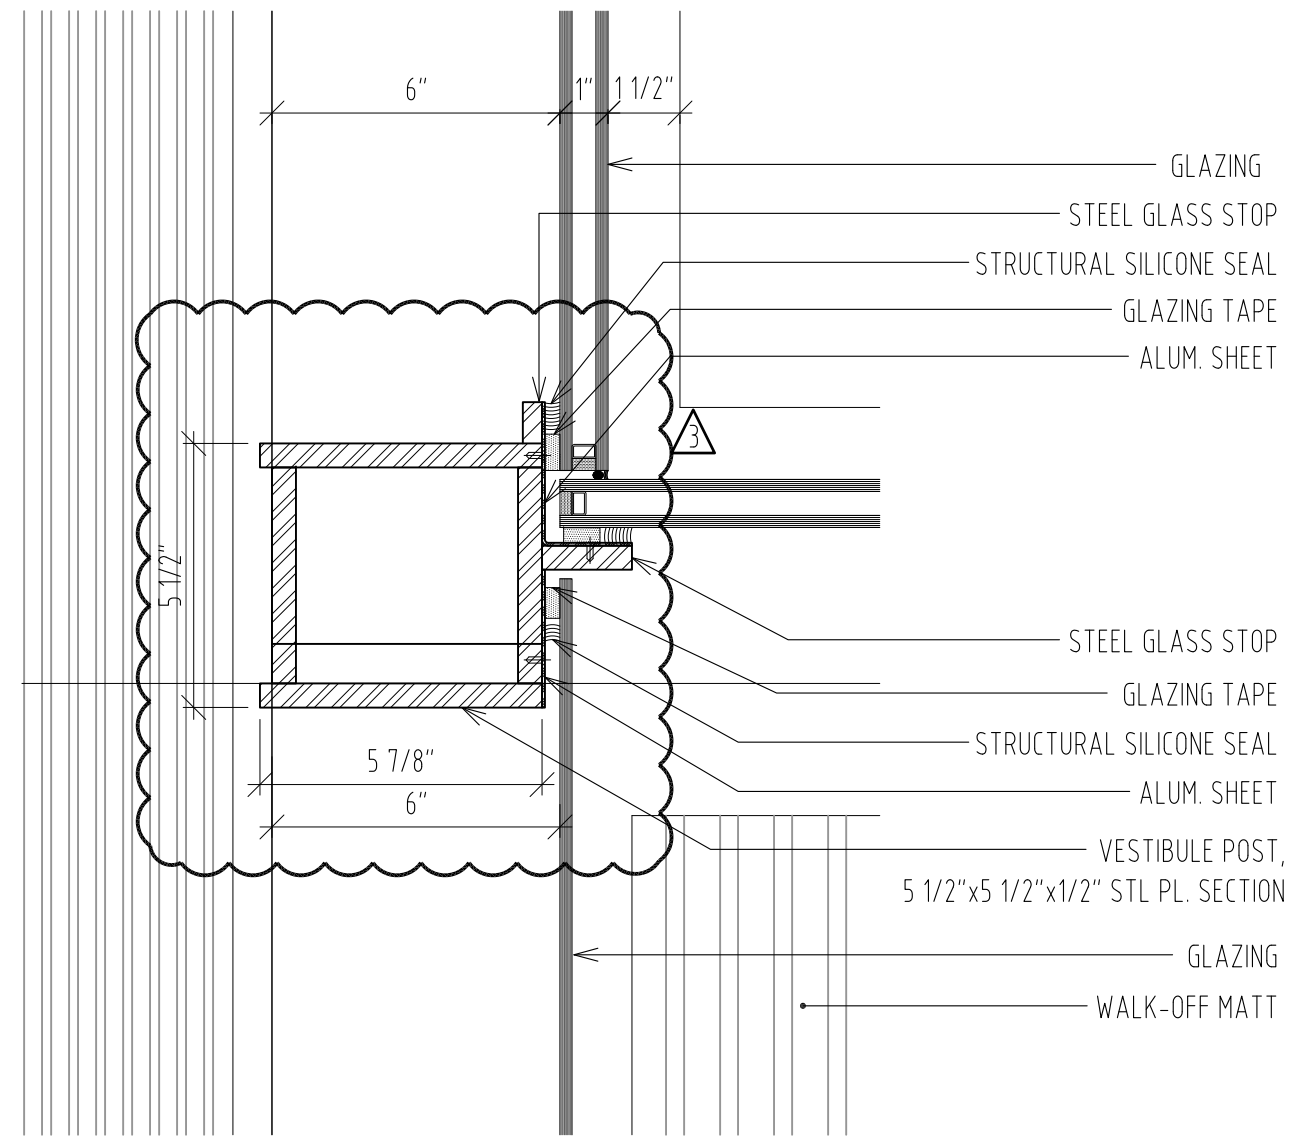

REF. DWG #02/A4621.5

EWS-2.1: DETAIL
SCALE : 3"=1'-0"

01

MOORE SCHOOL OF BUSINESS
UNIVERSITY OF SOUTH CAROLINA
BID PACKAGE 3
ENCLOSURE/SITE/MEFP/INTERIOR
ADDENDUM #003

PROJECT NO. 655.000


^ ^
K K
3 2012.06.22
© RAFAEL VINOLY ARCHITECTS PC

VESTIBULE TYPICAL DETAIL REVISION
REF. DWG # A4621.5

SHEET TITLE :


SCALE :
3" = 1'-0"

SHEET NUMBER :
A-SK-080

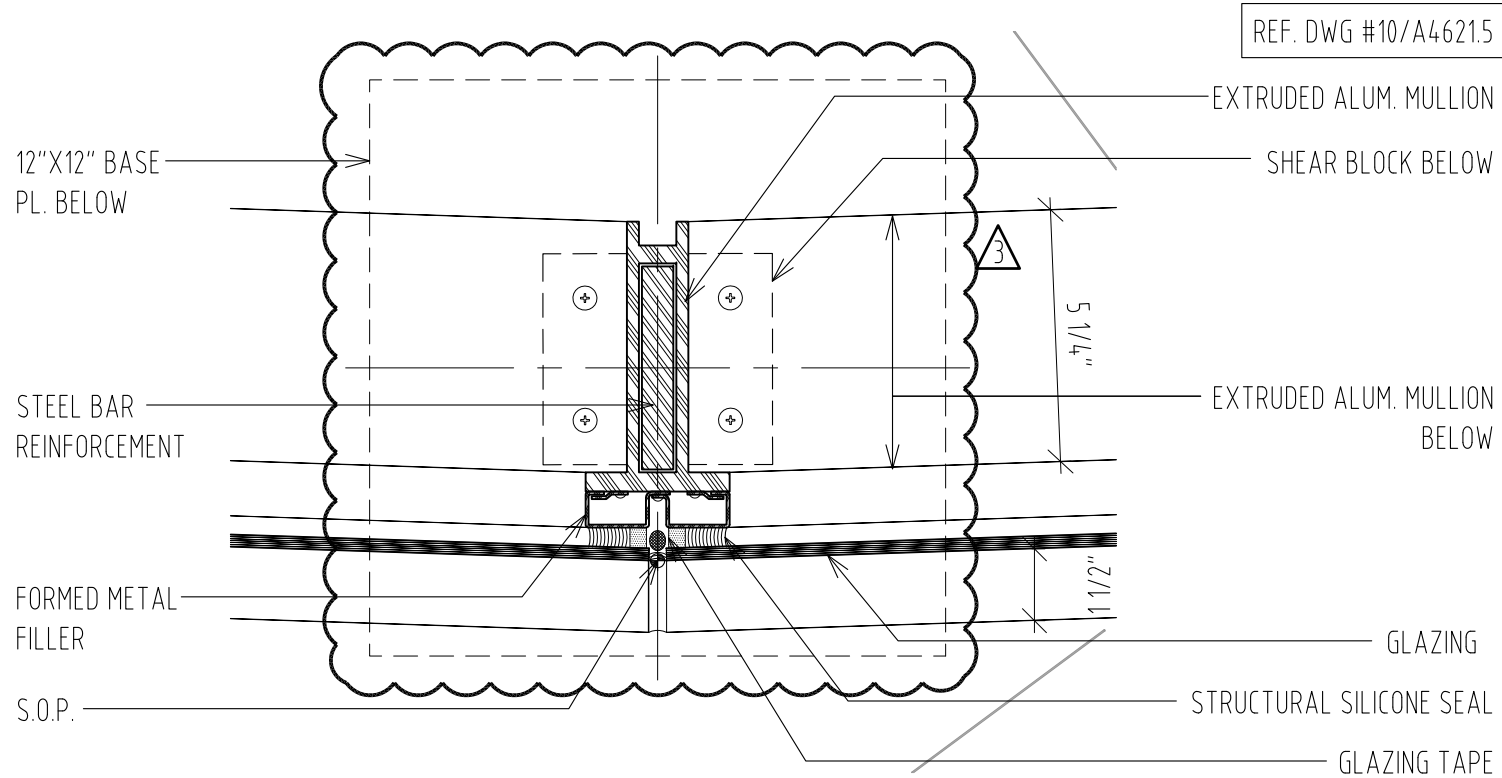


EWS-2.1: DETAIL
SCALE : 3"=1'-0"

03

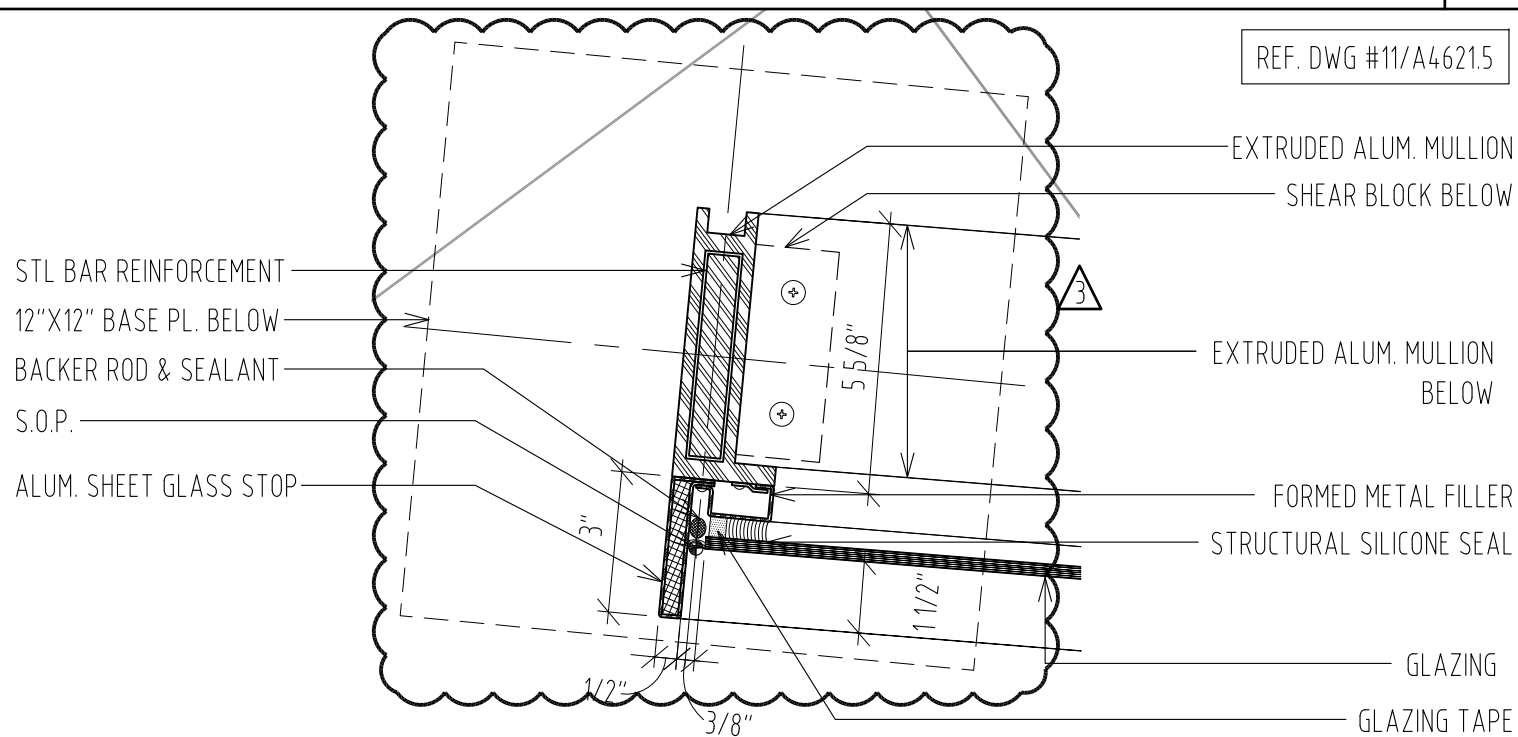

EWS-2.1: DETAIL
SCALE : 3"=1'-0"


02

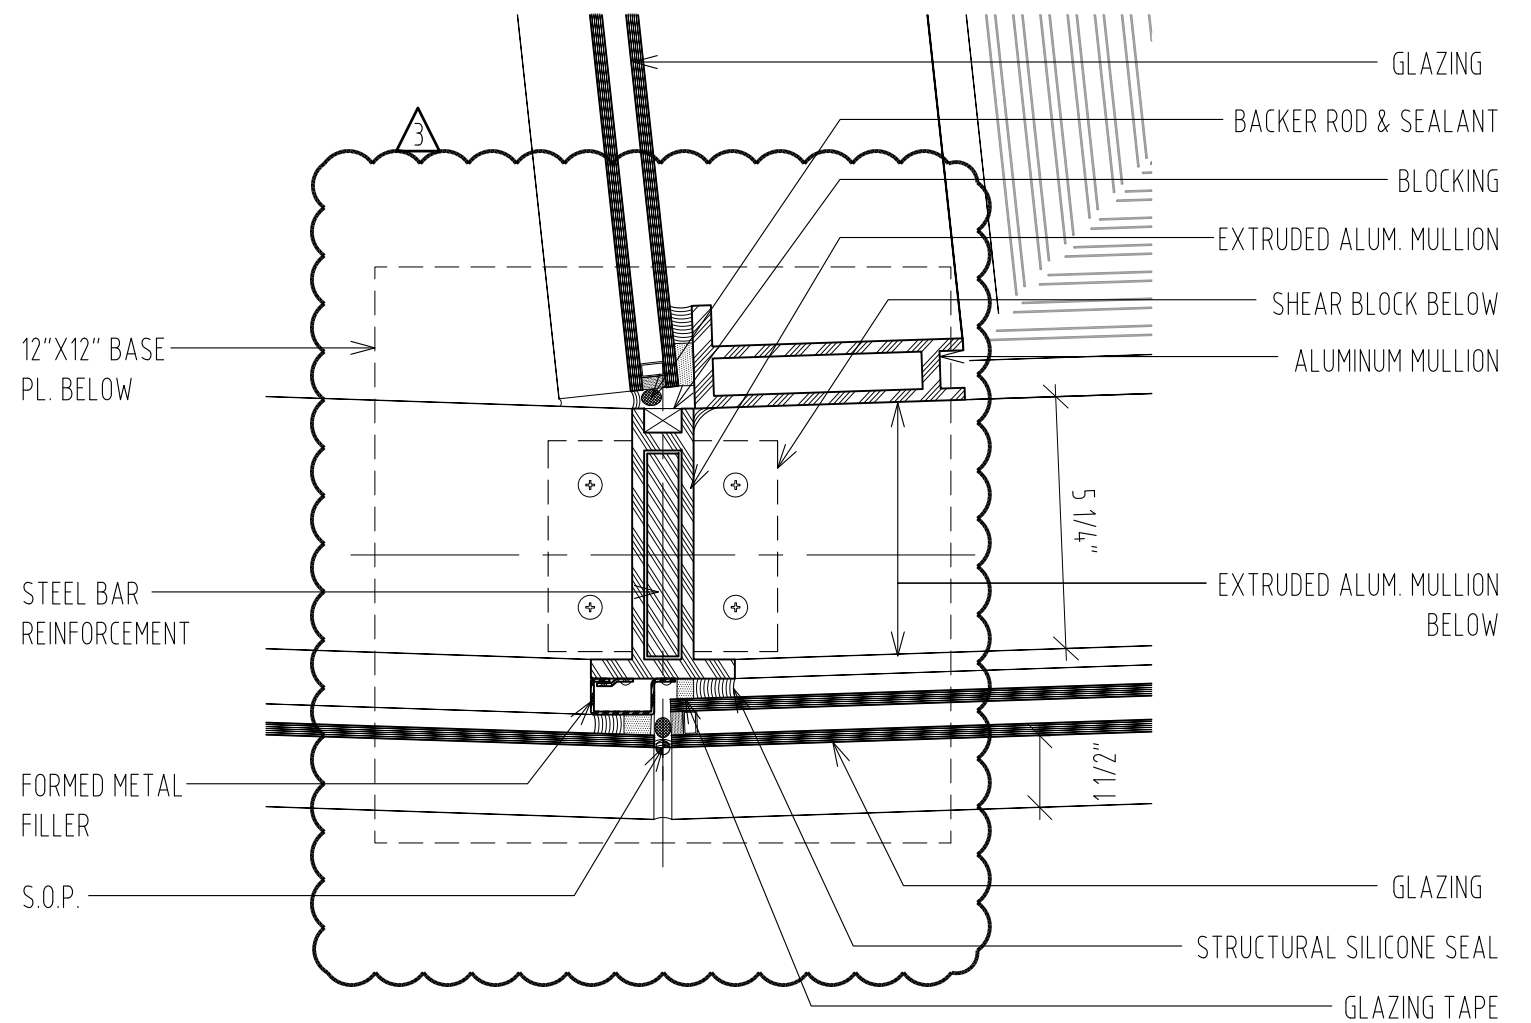

EWS-2.1: DETAIL
SCALE : 3"=1'-0"

01

SEE A-SK-083
MATCHLINE

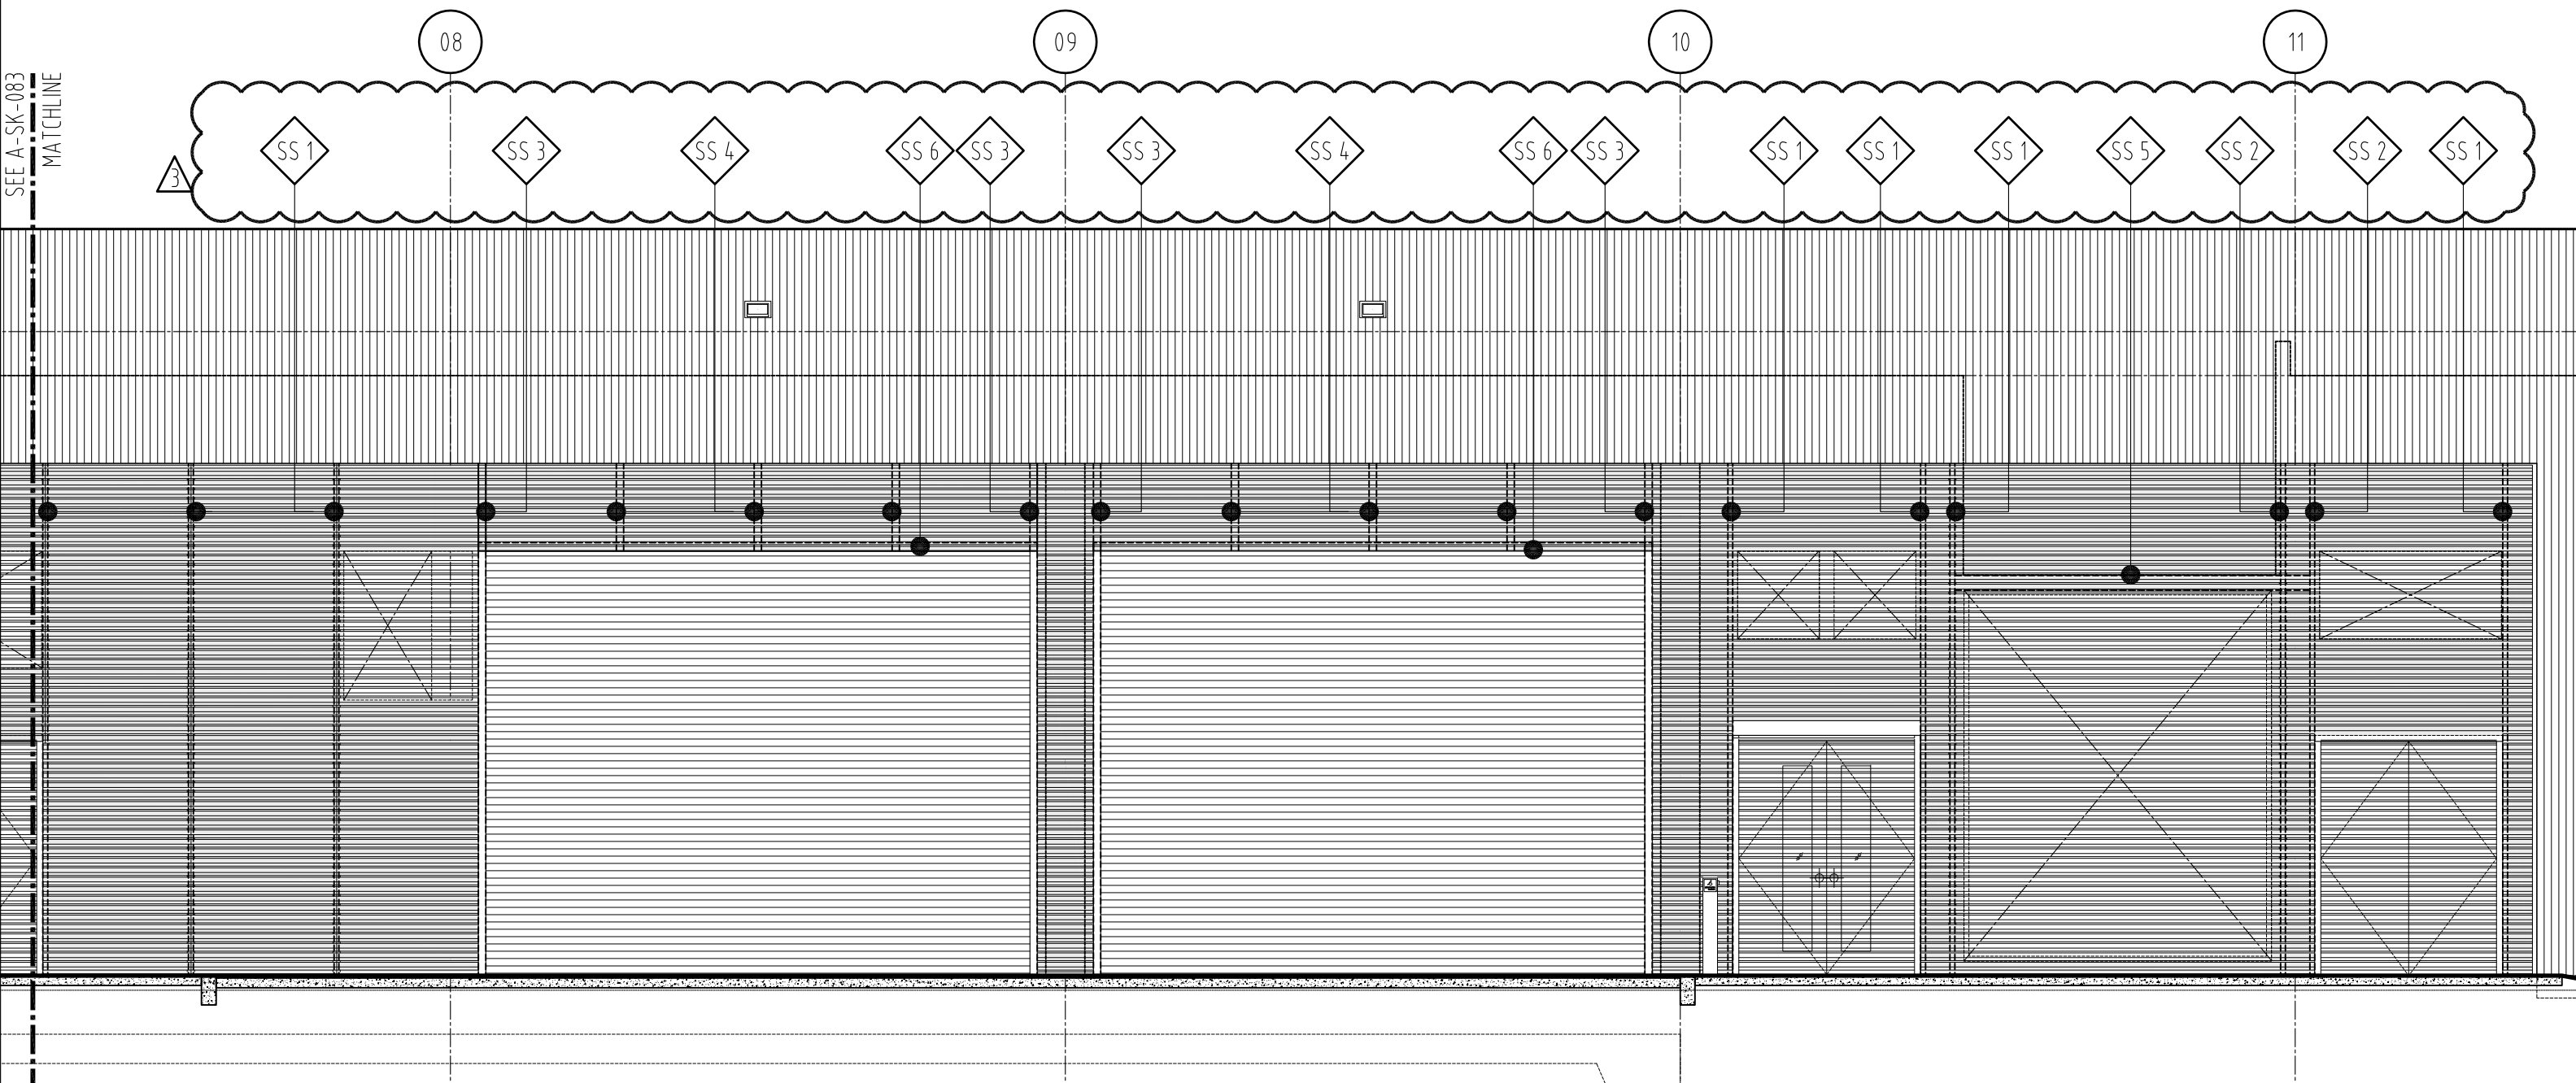

LEGEND:

SS 1 HSS6X3X1/2" W/
3/8"X6"X9" BASE PLATE

SS 2 HSS4X4X1/4" @ CONCRETE COLUMN
W/ 3/8"X4"X9" BASE PLATE, W/
L3X3X3/8 x 0'-3" CLIP @ 1/4 POINTS

SS 3 HSS9X3X1/2" W/ 3/8"X9"X9"
BASE PLATE @ ROLL-UP
DOOR JAMBS

SS 4 HSS6X3X1/4" HANGER OVER
ROLL-UP DOOR

SS 5 HSS6X6X3/8"

SS 6 HSS9X9X3/8"

EWS-0.1 REVISED ENLARGED ELEVATION
SCALE 3/16" = 1'-0"


01

MOORE SCHOOL OF BUSINESS
UNIVERSITY OF SOUTH CAROLINA
BID PACKAGE 3
ENCLOSURE/SITE/MEPFP/INTERIOR
ADDENDUM #003
PROJECT NO. 655.000

2012.06.22
RAFAEL VINOLY ARCHITECTS PC

WEST LOUVER WALL STEEL SECTIONS_01
REF DWG A4610.0, A4610.1, A4610.2, A4601.2A, A4601.3, A4601.6, A4601.7, A4601.8
SHEET TITLE :

SCALE :
3/16" = 1'-0"
SHEET NUMBER :
A-SK-082

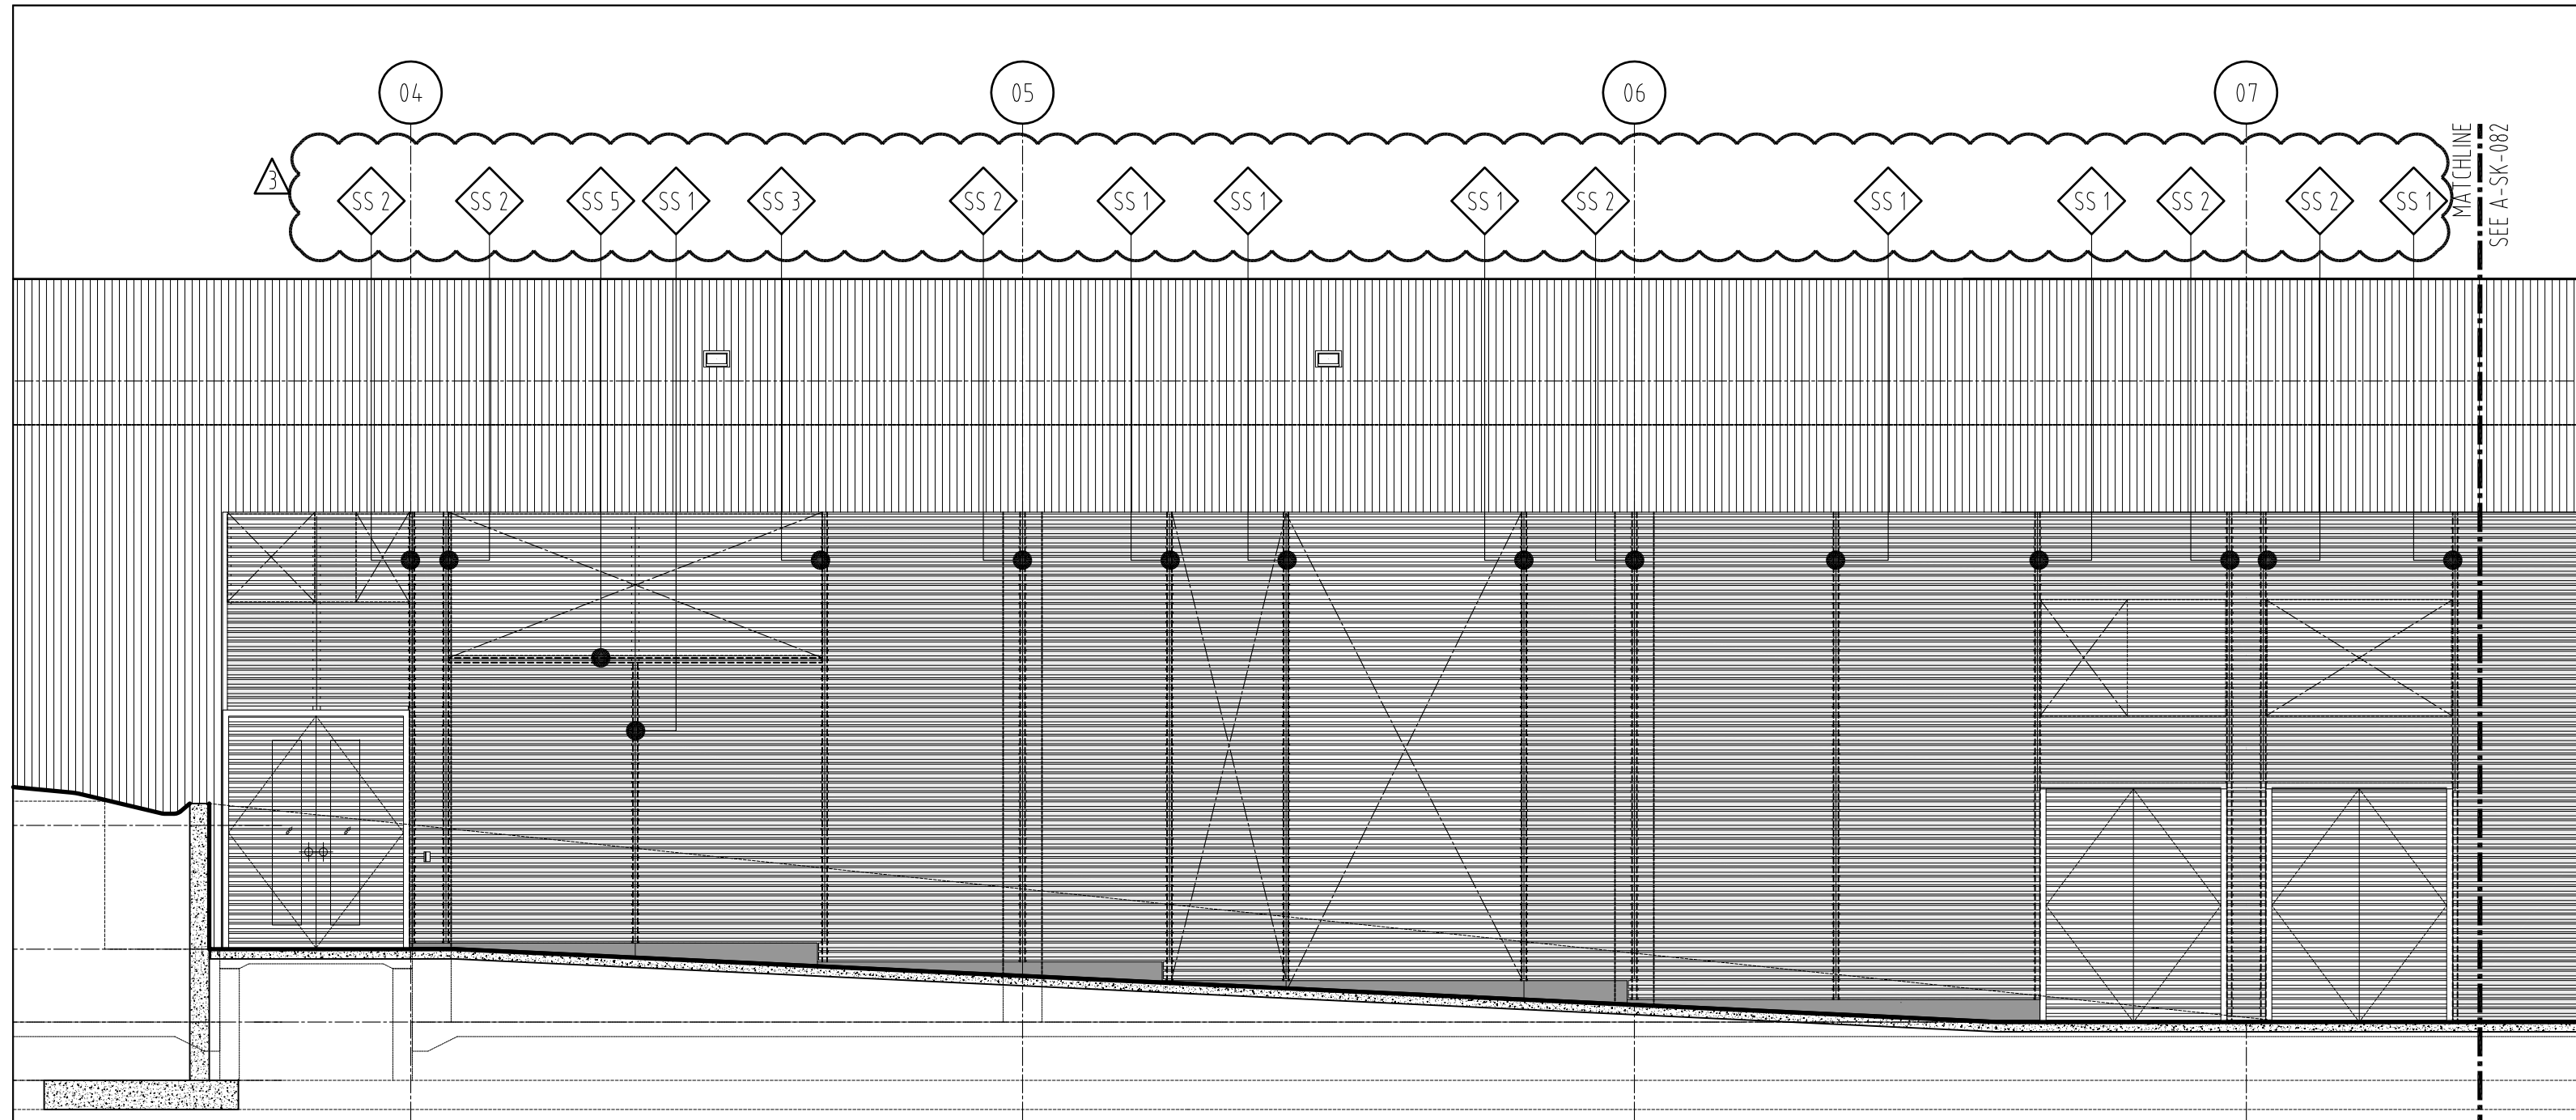

LEGEND:

-


MOORE SCHOOL OF BUSINESS
 UNIVERSITY OF SOUTH CAROLINA
 BID PACKAGE 3
 ENCLOSURE/SITE/MEPFP/INTERIOR
 ADDENDUM #003
 PROJECT NO. 655.000

2012.06.22
 RAFAEL VINOLY ARCHITECTS PC

WEST LOUVER WALL STEEL SECTIONS_02
 REF DWG A4610.0, A4610.1, A4610.2, A4601.2A, A4601.3, A4601.6, A4601.7, A4601.8
 SHEET TITLE :

EWS-0.1 REVISED ENLARGED ELEVATION
 SCALE 3/16" = 1'-0" 01

SCALE :
 3/16" = 1'-0"
 SHEET NUMBER :
 A-SK-083

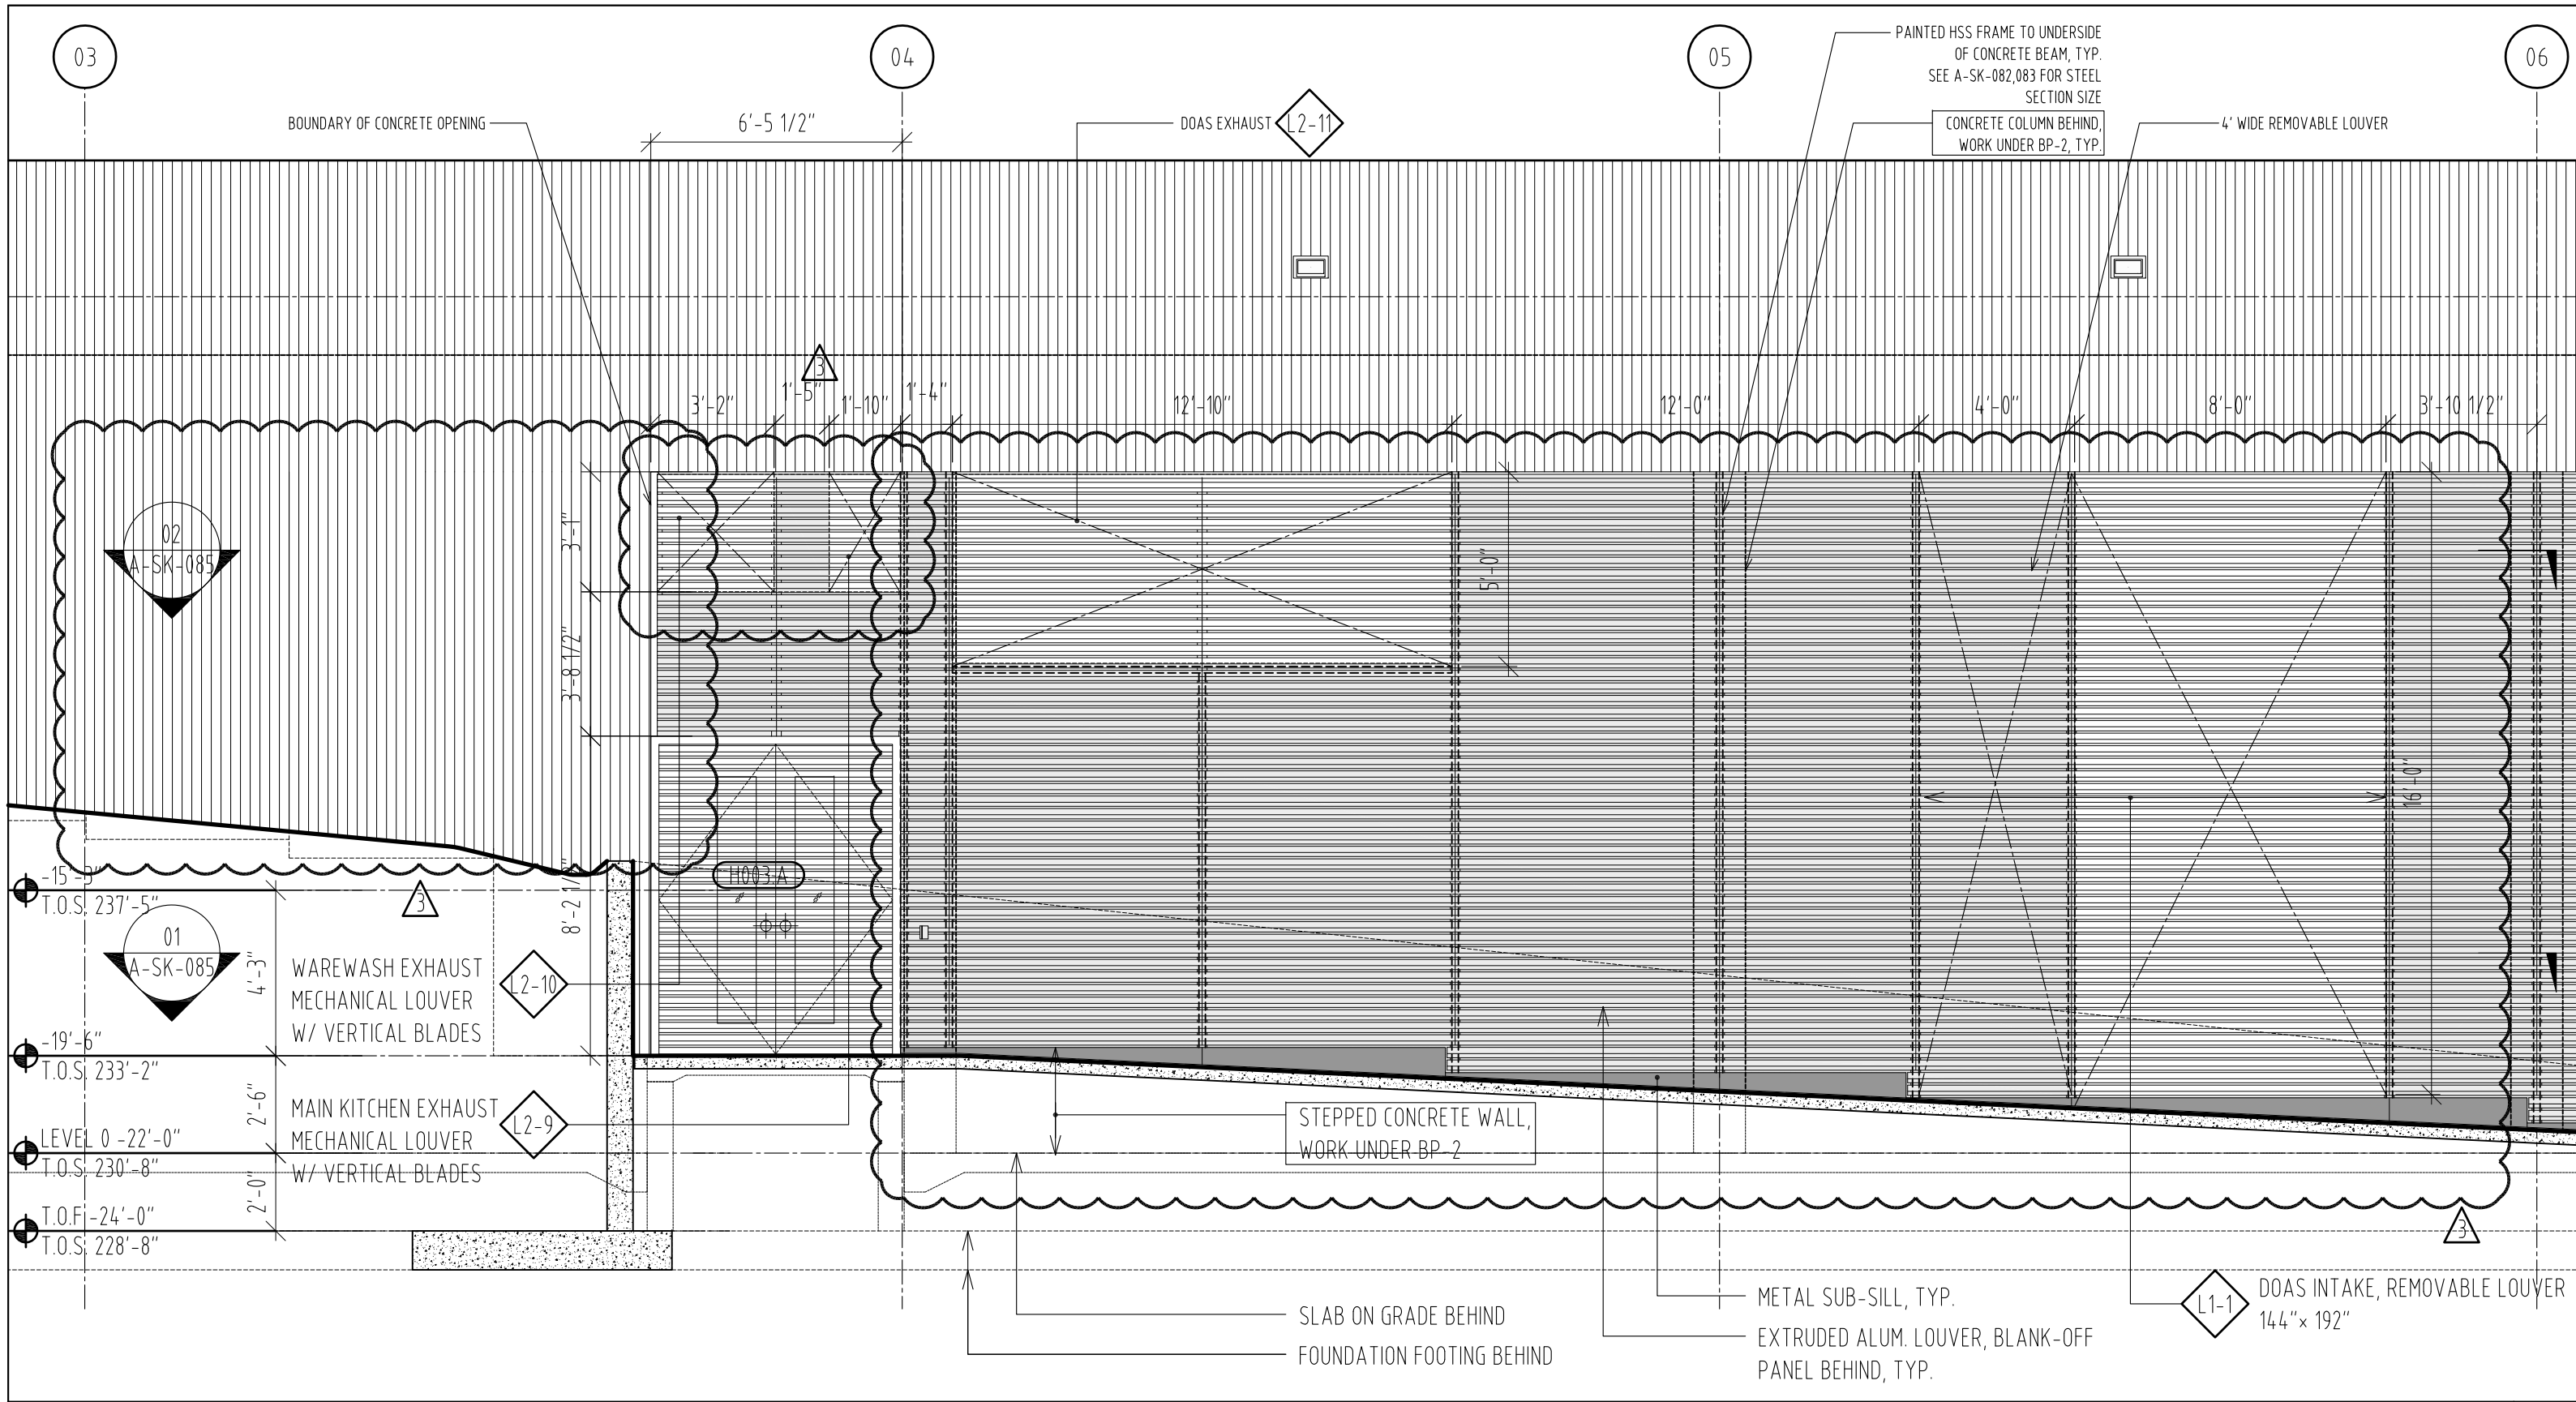


EWS-0.1 REVISED ENLARGED ELEVATION
SCALE 1/4" = 1'-0" 01

MOORE SCHOOL OF BUSINESS
UNIVERSITY OF SOUTH CAROLINA
BID PACKAGE 3
ENCLOSURE/SITE/MEFP/INTERIOR
ADDENDUM #003
PROJECT NO. 655.000


2012.06.22
RAFAEL VINOLY ARCHITECTS PC

WEST LOUVER WALL REVISION
REF DWG 01/A2102, 01/A2221, A4610.0_BP3, A4610.3_BP3
SHEET TITLE :

SCALE :
1/4" = 1'-0"
SHEET NUMBER :
A-SK-084

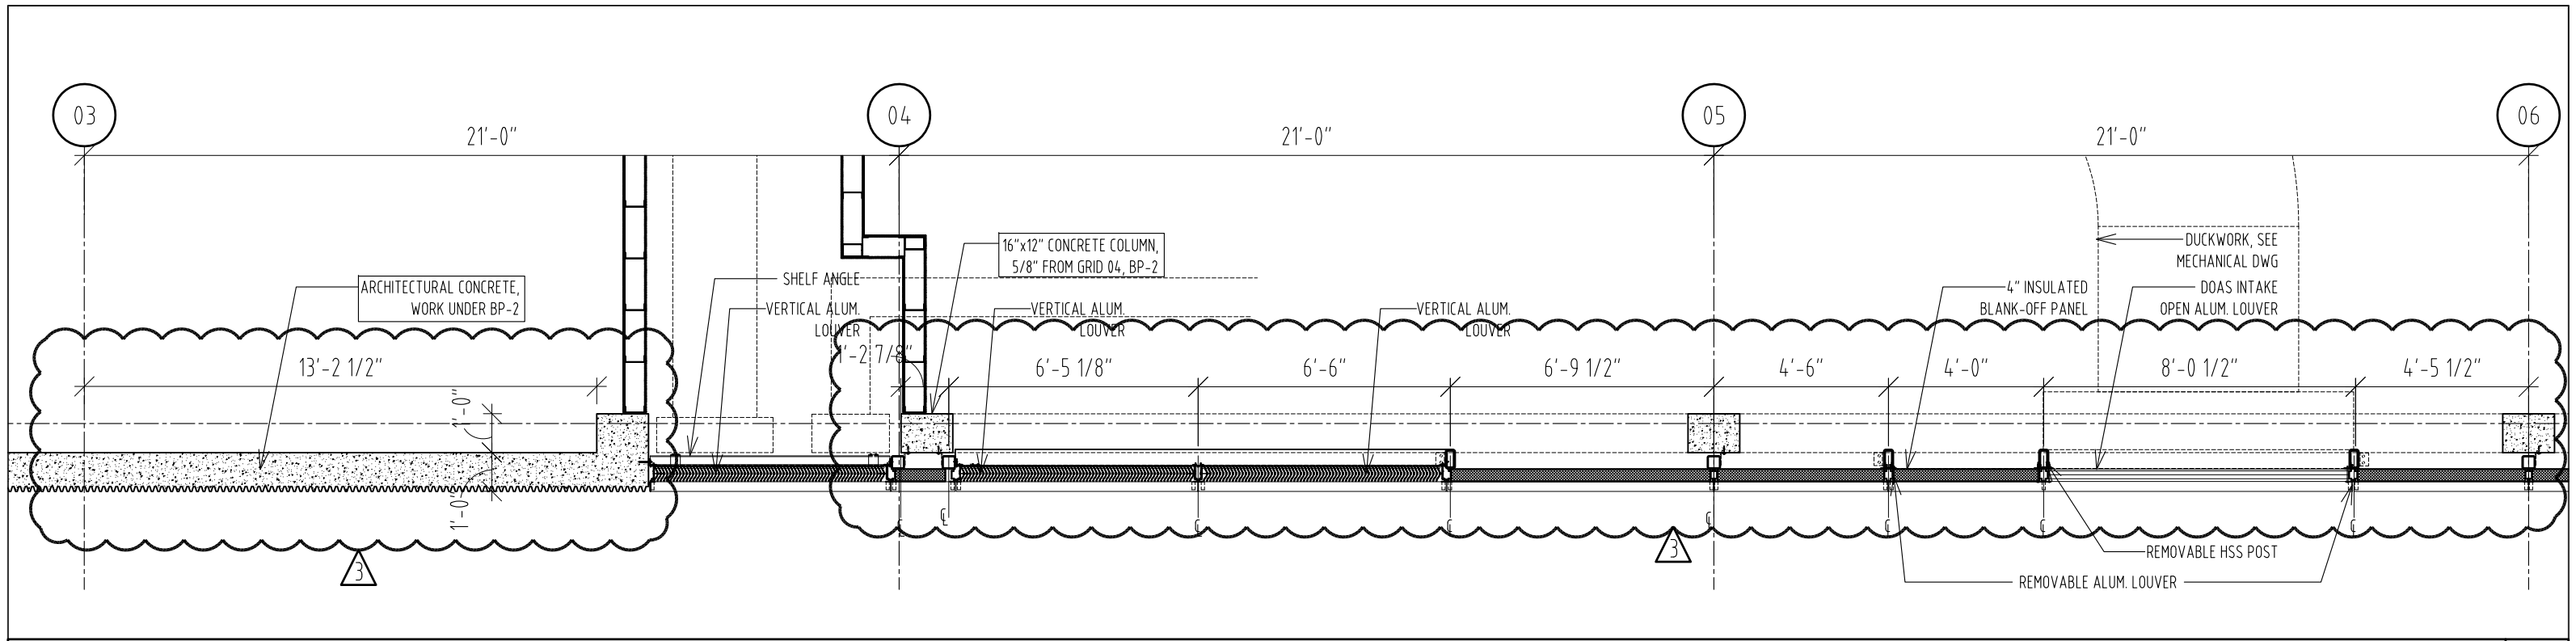

EWS-0.1 REVISED ENLARGED PLAN
SCALE 1/4" = 1'-0" 02

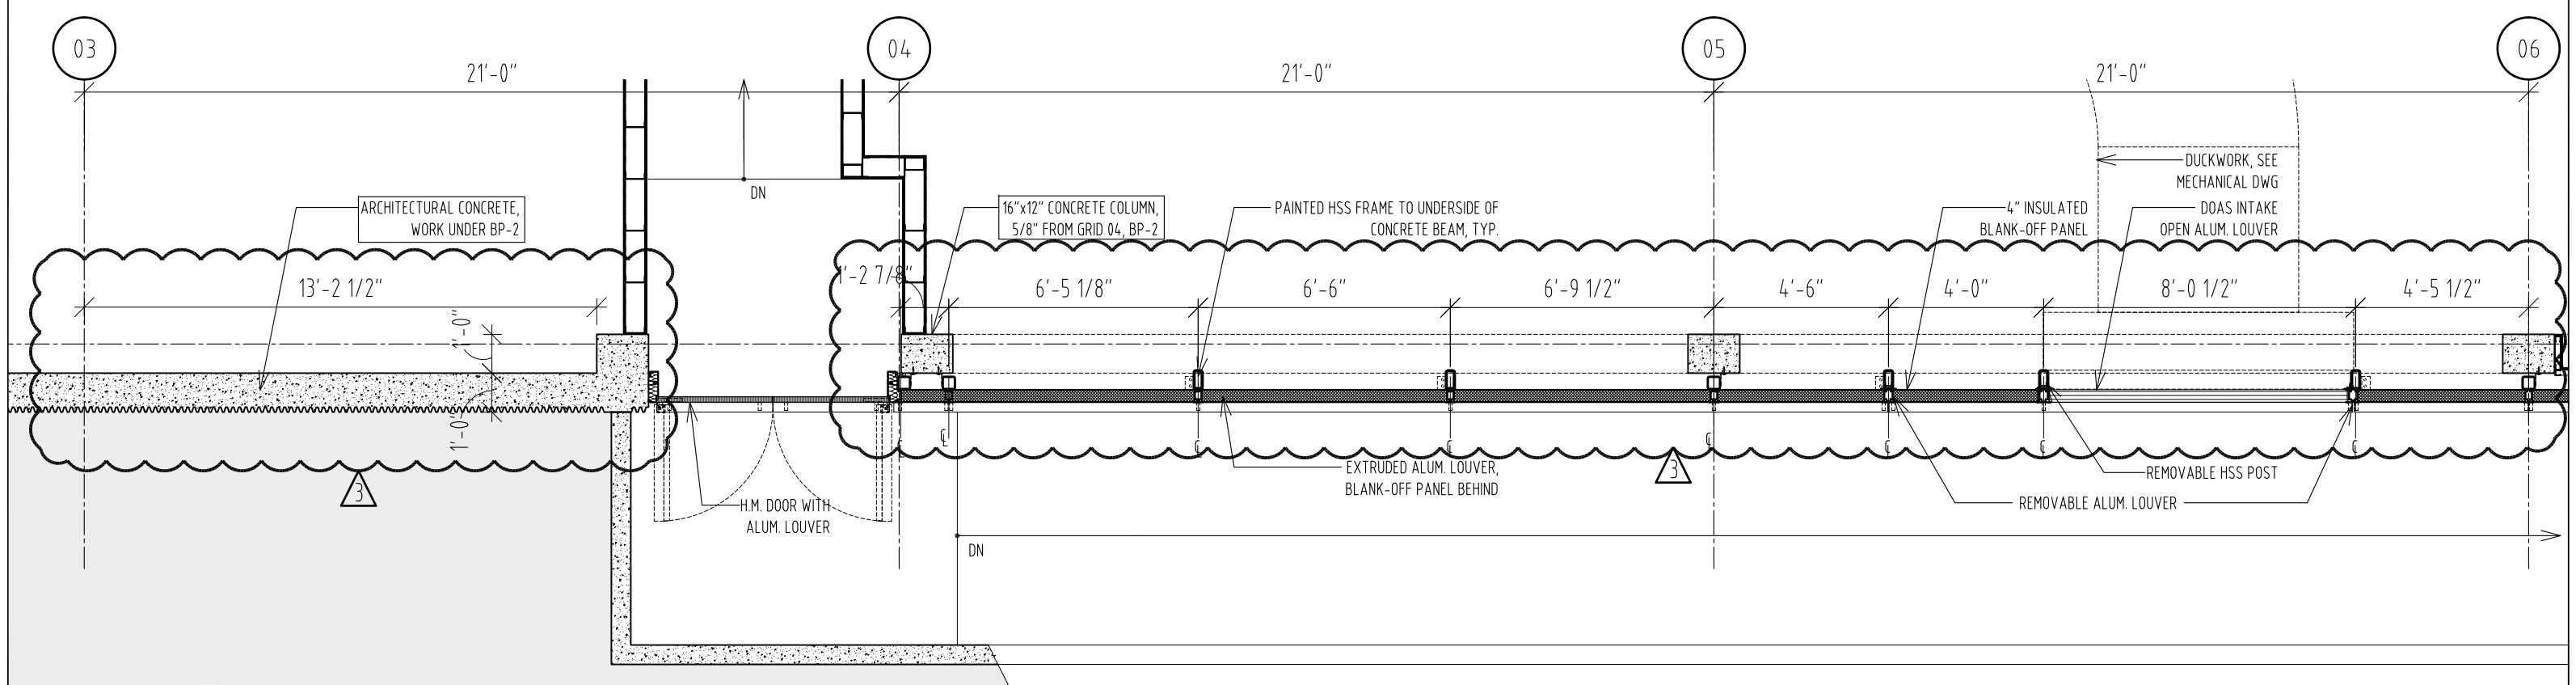

EWS-0.1 REVISED ENLARGED PLAN
SCALE 1/4" = 1'-0" 01


MOORE SCHOOL OF BUSINESS
UNIVERSITY OF SOUTH CAROLINA
BID PACKAGE 3
ENCLOSURE/SITE/MEPFP/INTERIOR
ADDENDUM #002
PROJECT NO. 655.000

2012.06.13
RAFAEL VINOLY ARCHITECTS PC

WEST LOUVER WALL REVISION
REF DWG A4610.3_BP3
SHEET TITLE :

SCALE :
1/4" = 1'-0"
SHEET NUMBER :
A-SK-085

05 08

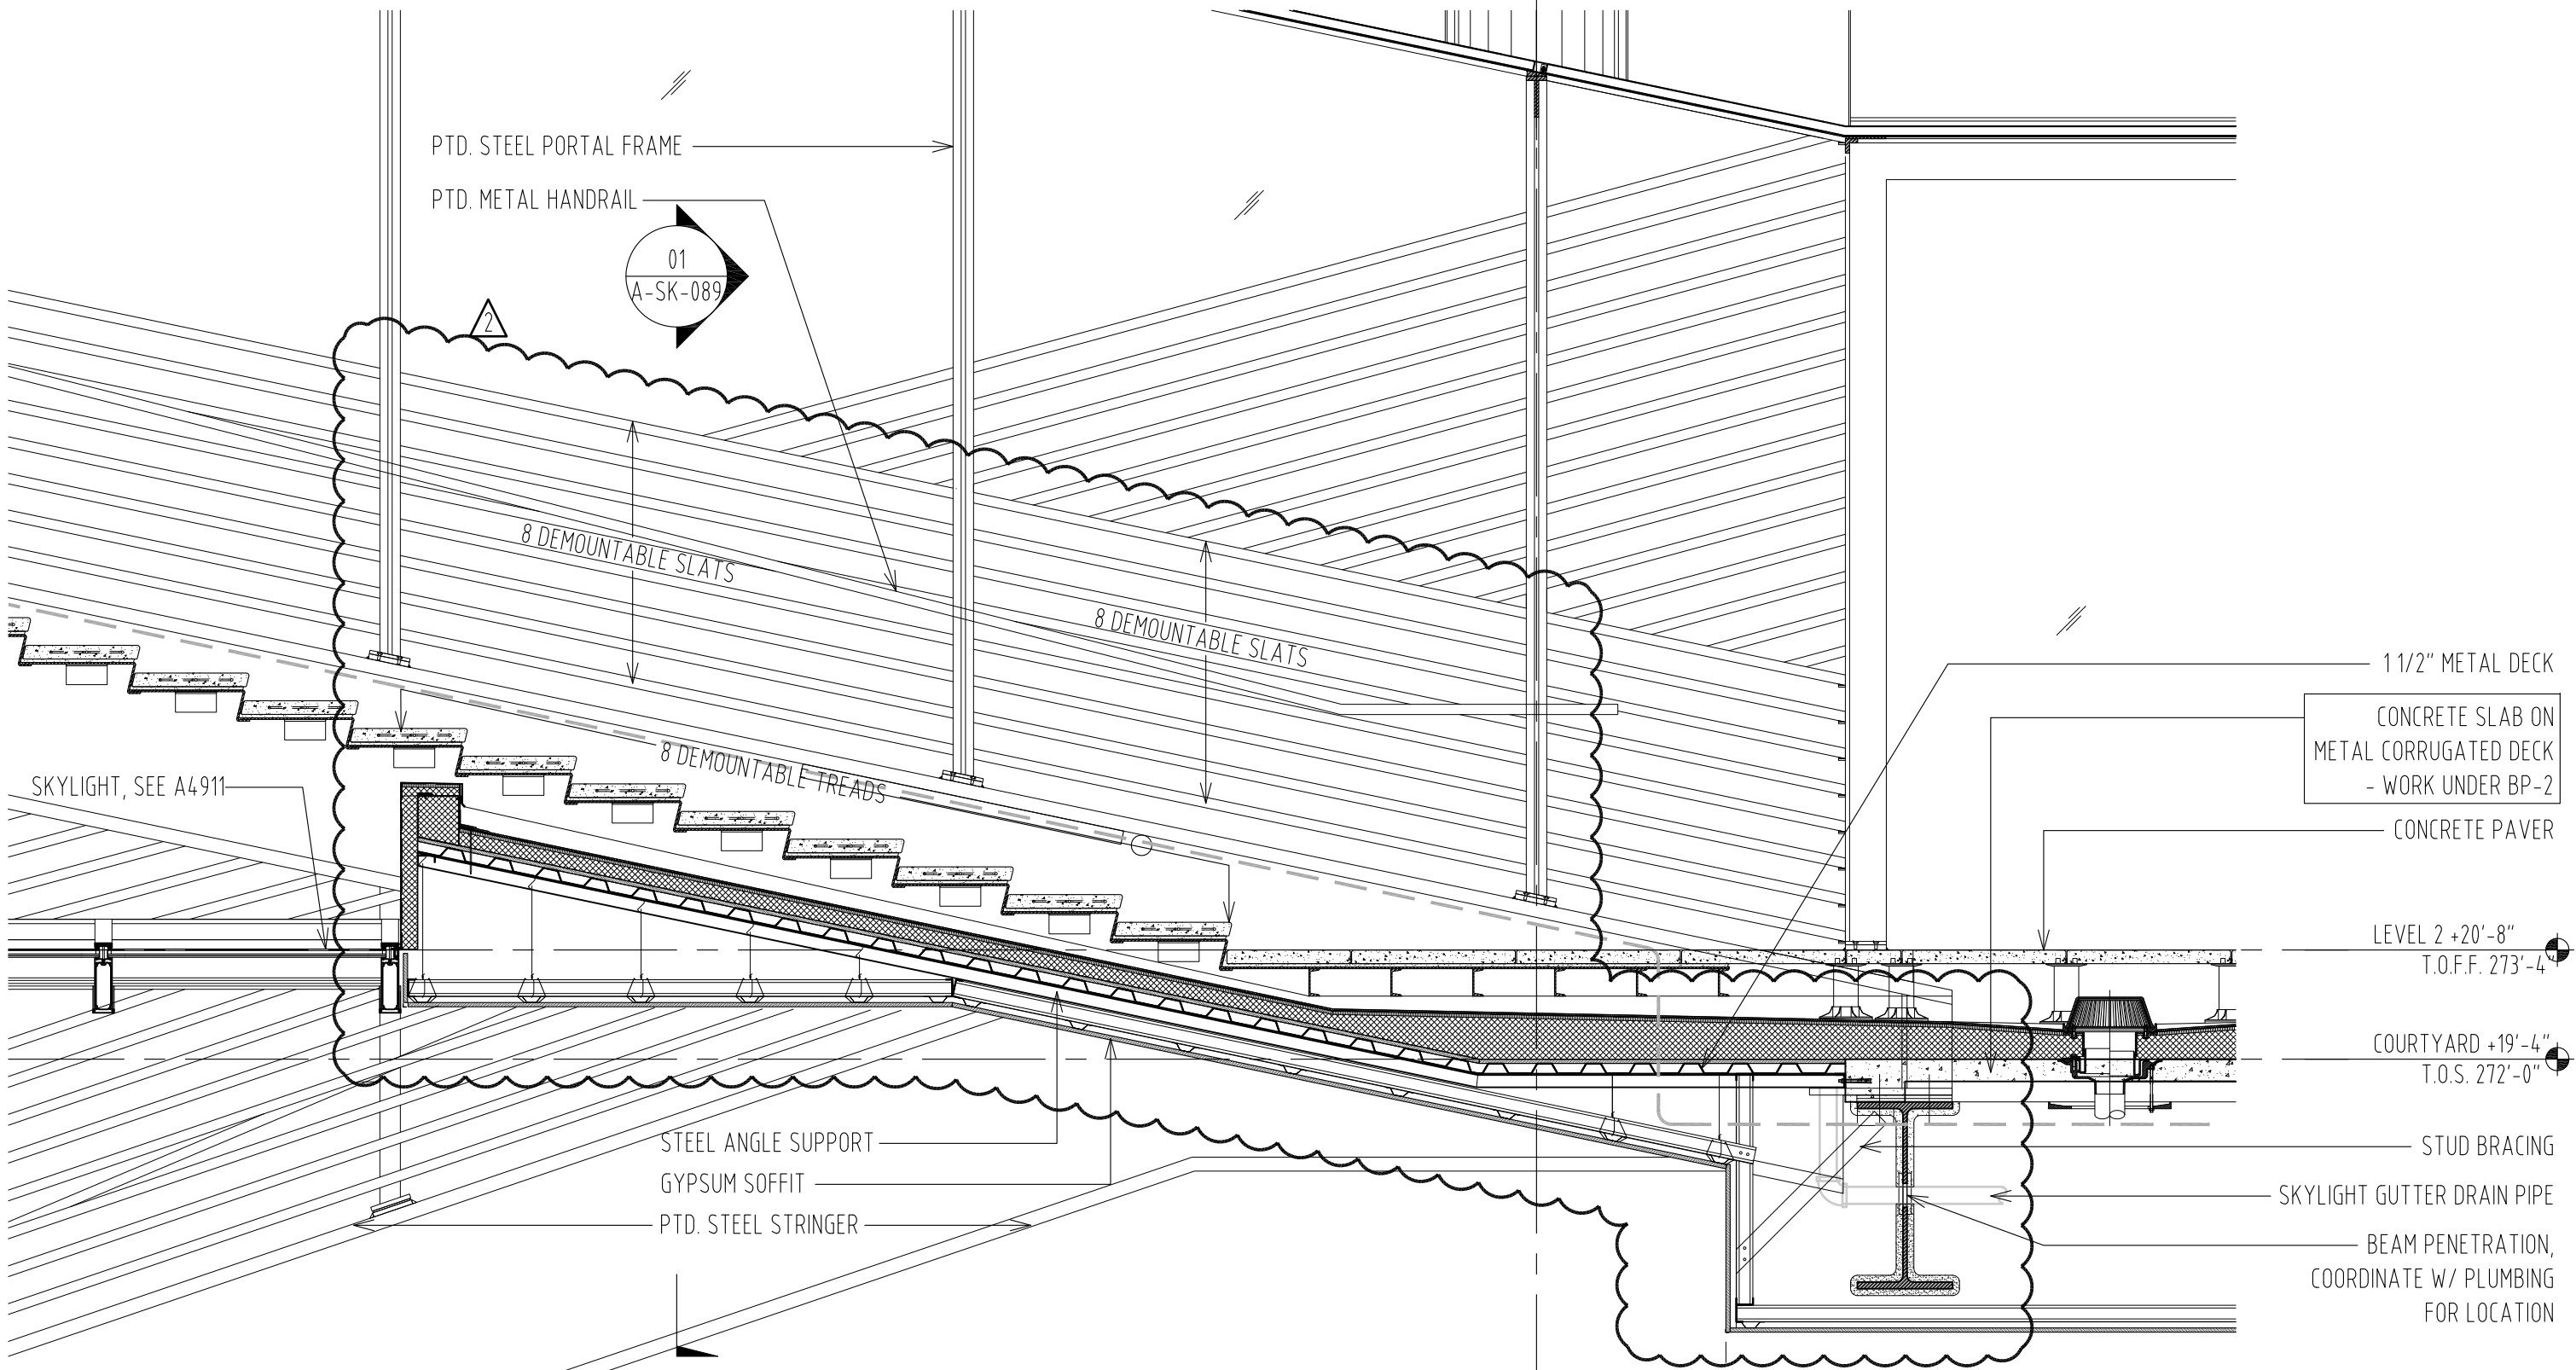

PTD. STEEL PORTAL FRAME

PTD. METAL HANDRAIL

01
A-SK-089

8 DEMOUNTABLE SLATS

8 DEMOUNTABLE SLATS

8 DEMOUNTABLE TREADS

SKYLIGHT, SEE A4911

1 1/2" METAL DECK

CONCRETE SLAB ON METAL CORRUGATED DECK - WORK UNDER BP-2

CONCRETE PAVER

LEVEL 2 +20'-8" T.O.F.F. 273'-4"

COURTYARD +19'-4" T.O.S. 272'-0"

STEEL ANGLE SUPPORT

GYPSON SOFFIT

PTD. STEEL STRINGER

STUD BRACING

SKYLIGHT GUTTER DRAIN PIPE

BEAM PENETRATION, COORDINATE W/ PLUMBING FOR LOCATION

STAIR 5 (STAIR 6 OPPOSITE) L2 LANDING SECTION
SCALE 1/2" = 1'-0" 01

MOORE SCHOOL OF BUSINESS
UNIVERSITY OF SOUTH CAROLINA
BID PACKAGE 3
ENCLOSURE/SITE/MEFP/INTERIOR
ADDENDUM #003


PROJECT NO. 655.000

2012.06.22
© RAFAEL VINOLY ARCHITECTS PC

GRAND STAIR L2 LANDING ENLARGED SECTION
REF. DWG # 03/A4426

SHEET TITLE :

SCALE :
1/2" = 1'-0"
SHEET NUMBER :
A-SK-086

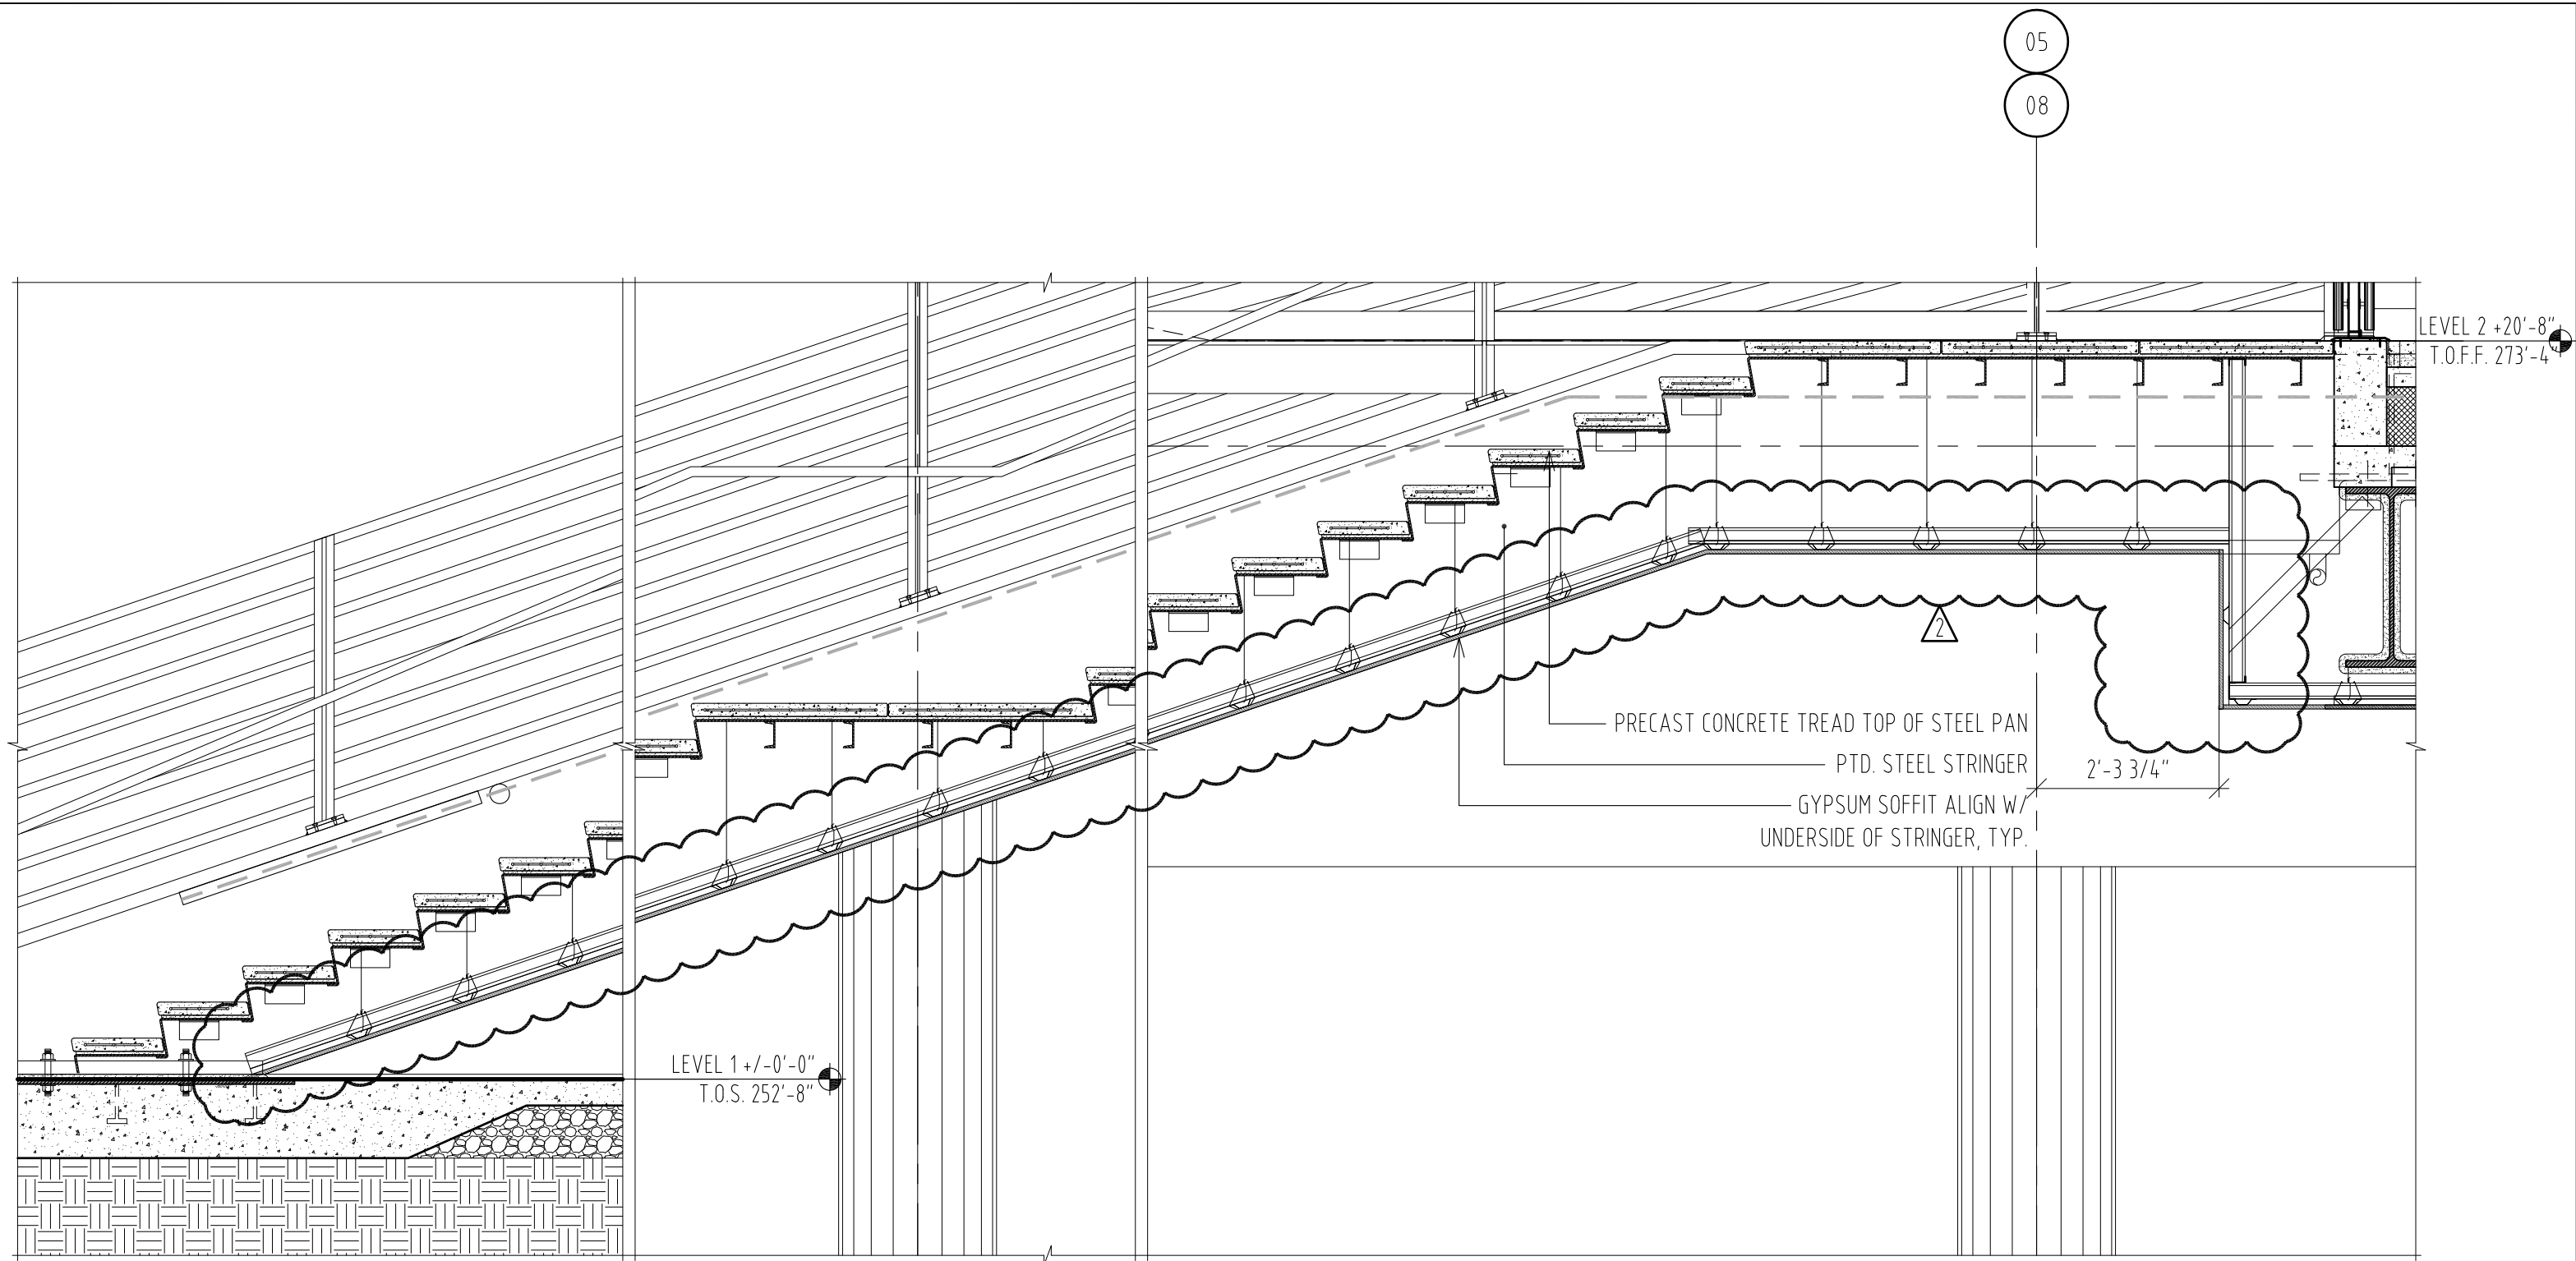

STAIR 5 (STAIR 6 OPPOSITE) L2 LANDING SECTION
SCALE 1/2" = 1'-0"

01

MOORE SCHOOL OF BUSINESS
UNIVERSITY OF SOUTH CAROLINA
BID PACKAGE 3
ENCLOSURE/SITE/MEFP/INTERIOR
ADDENDUM #003

PROJECT NO. 655.000


^ ^
^ ^
2012.06.22
© RAFAEL VINOLY ARCHITECTS PC

GRAND STAIR ENLARGED SECTION
REF. DWG # 02/A4429, 04/A4426

SHEET TITLE :

SCALE :
1/2" = 1'-0"

SHEET NUMBER :
A-SK-087

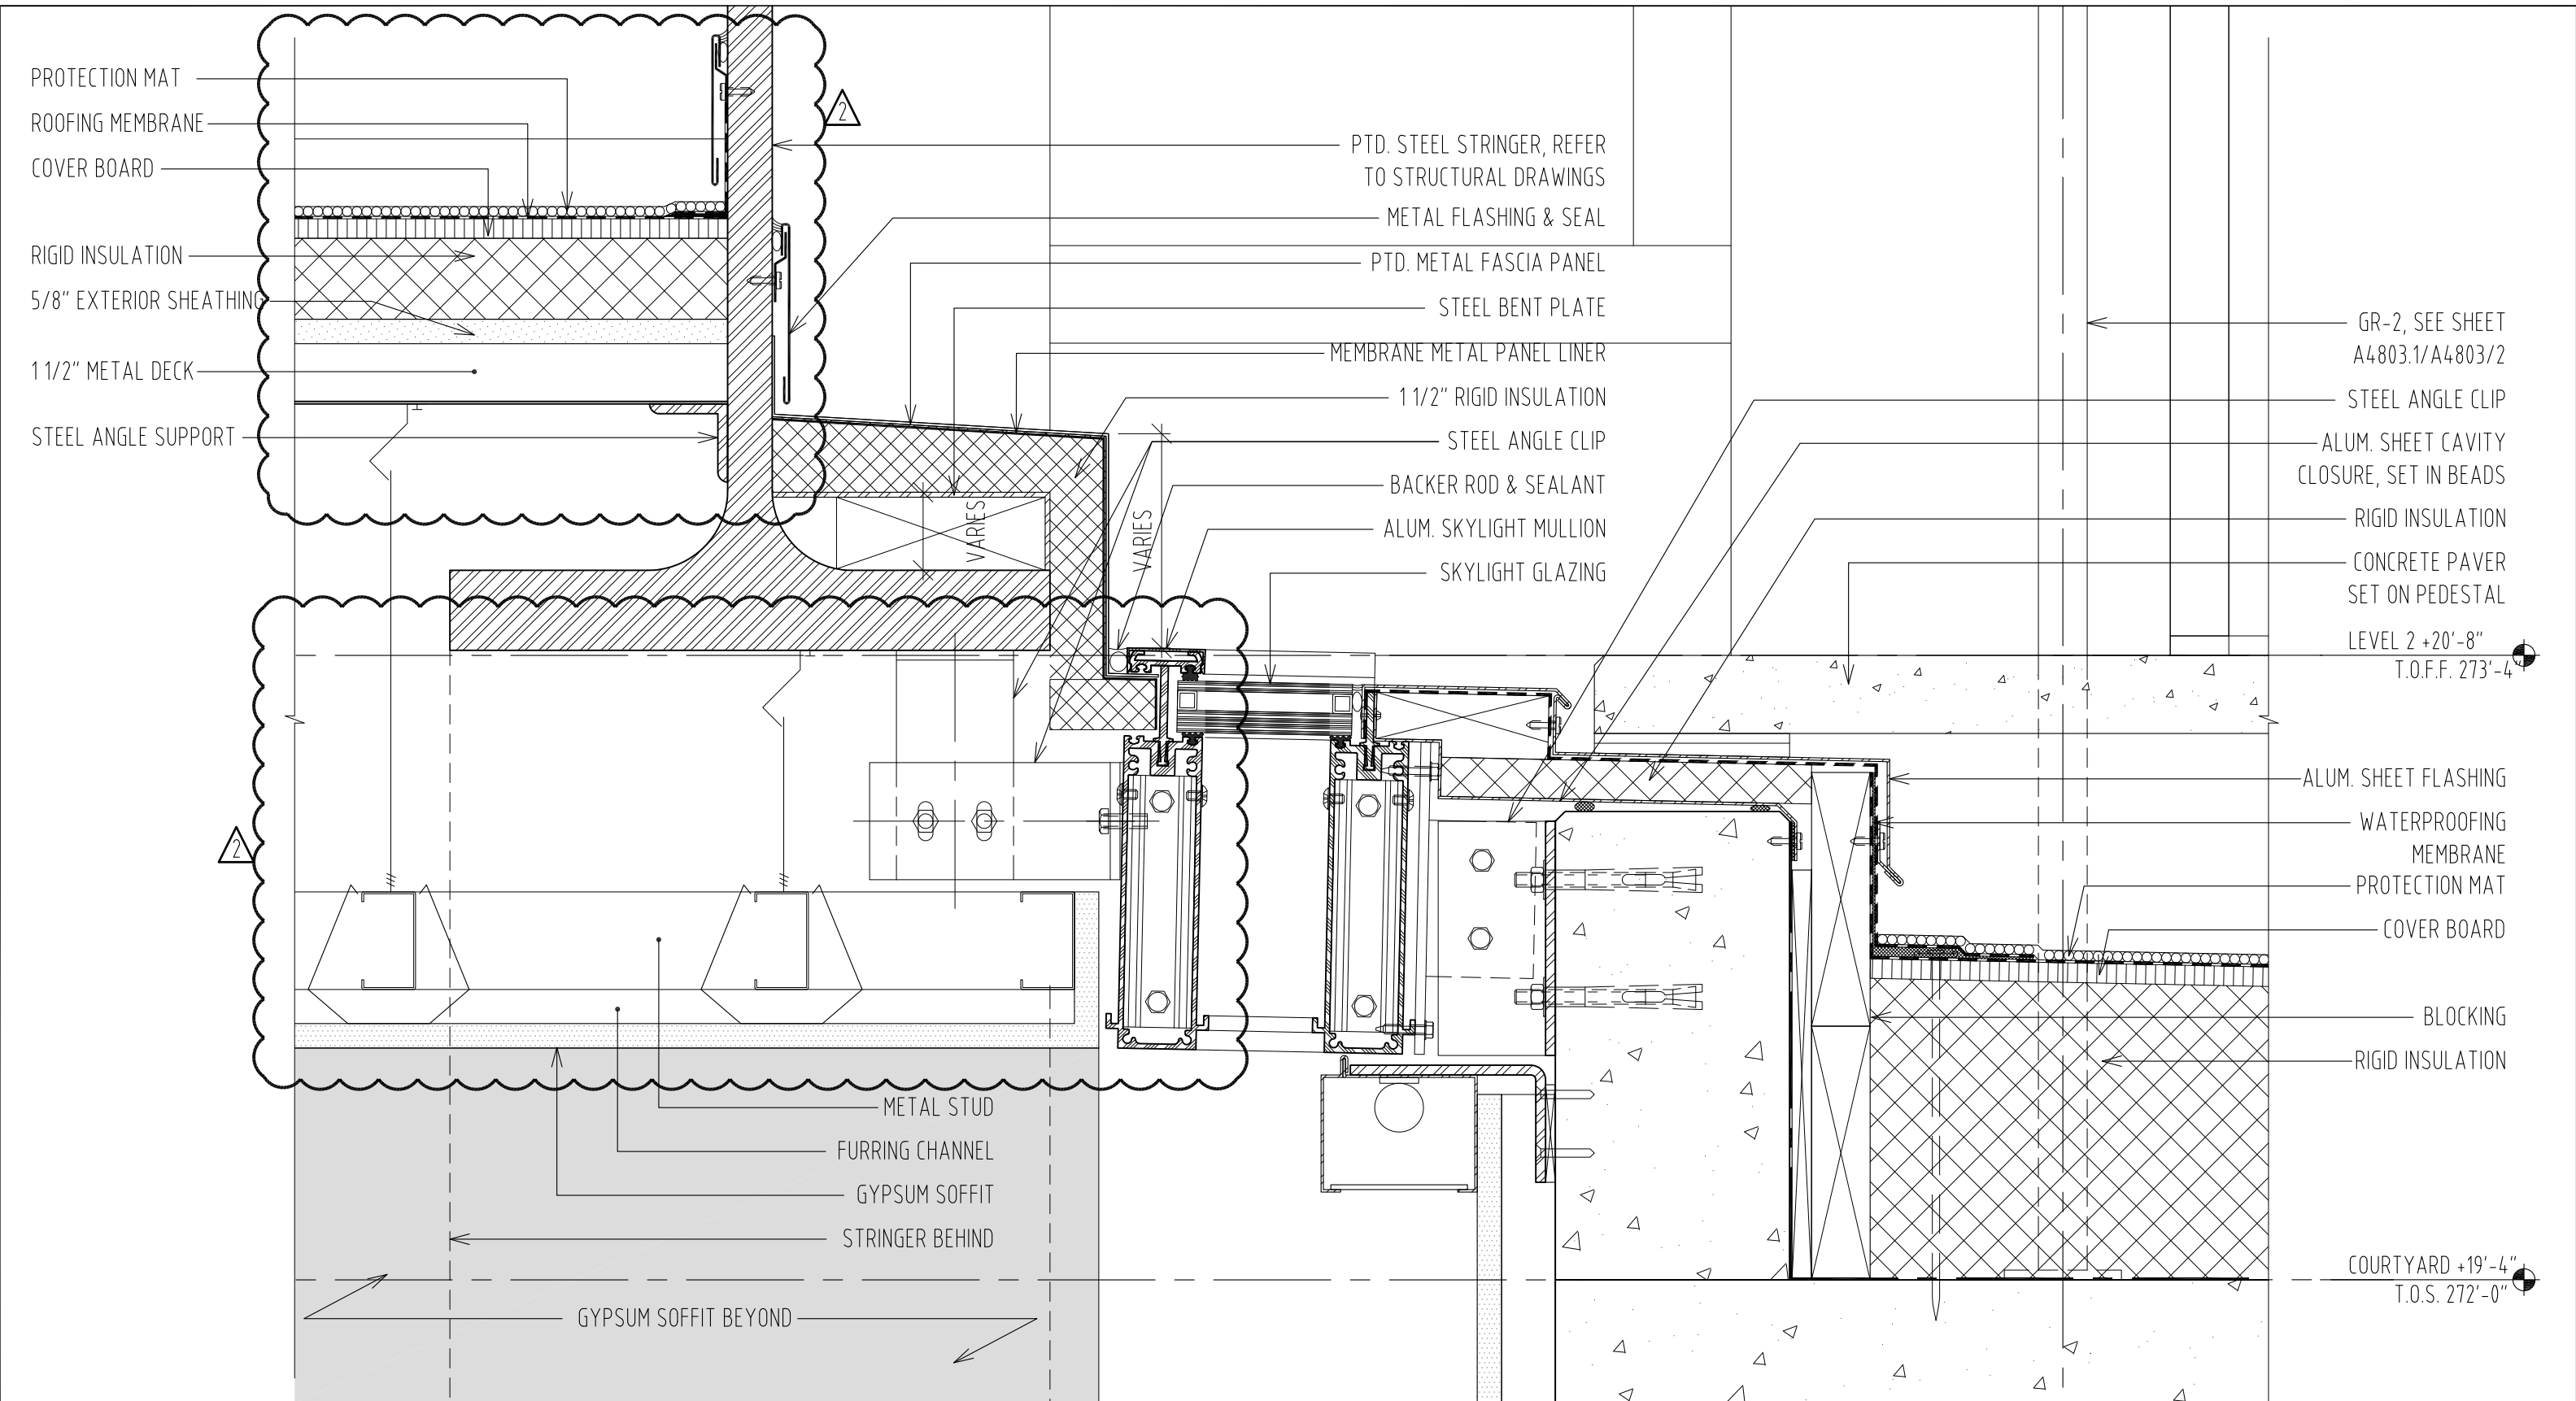

STAIR 5 (STAIR 6 OPPOSITE) SKYLIGHT DETAIL

SCALE 3" = 1'-0"


01

MOORE SCHOOL OF BUSINESS
UNIVERSITY OF SOUTH CAROLINA
BID PACKAGE 3
ENCLOSURE/SITE/MEFP/INTERIOR
ADDENDUM #003
PROJECT NO. 655.000

2012.06.22
© RAFAEL VINOLY ARCHITECTS PC

GRAND STAIR DETAIL REVISION_01
REF. DWG # 01/A4430
SHEET TITLE :

SCALE :
3" = 1'-0"
SHEET NUMBER :
A-SK-088

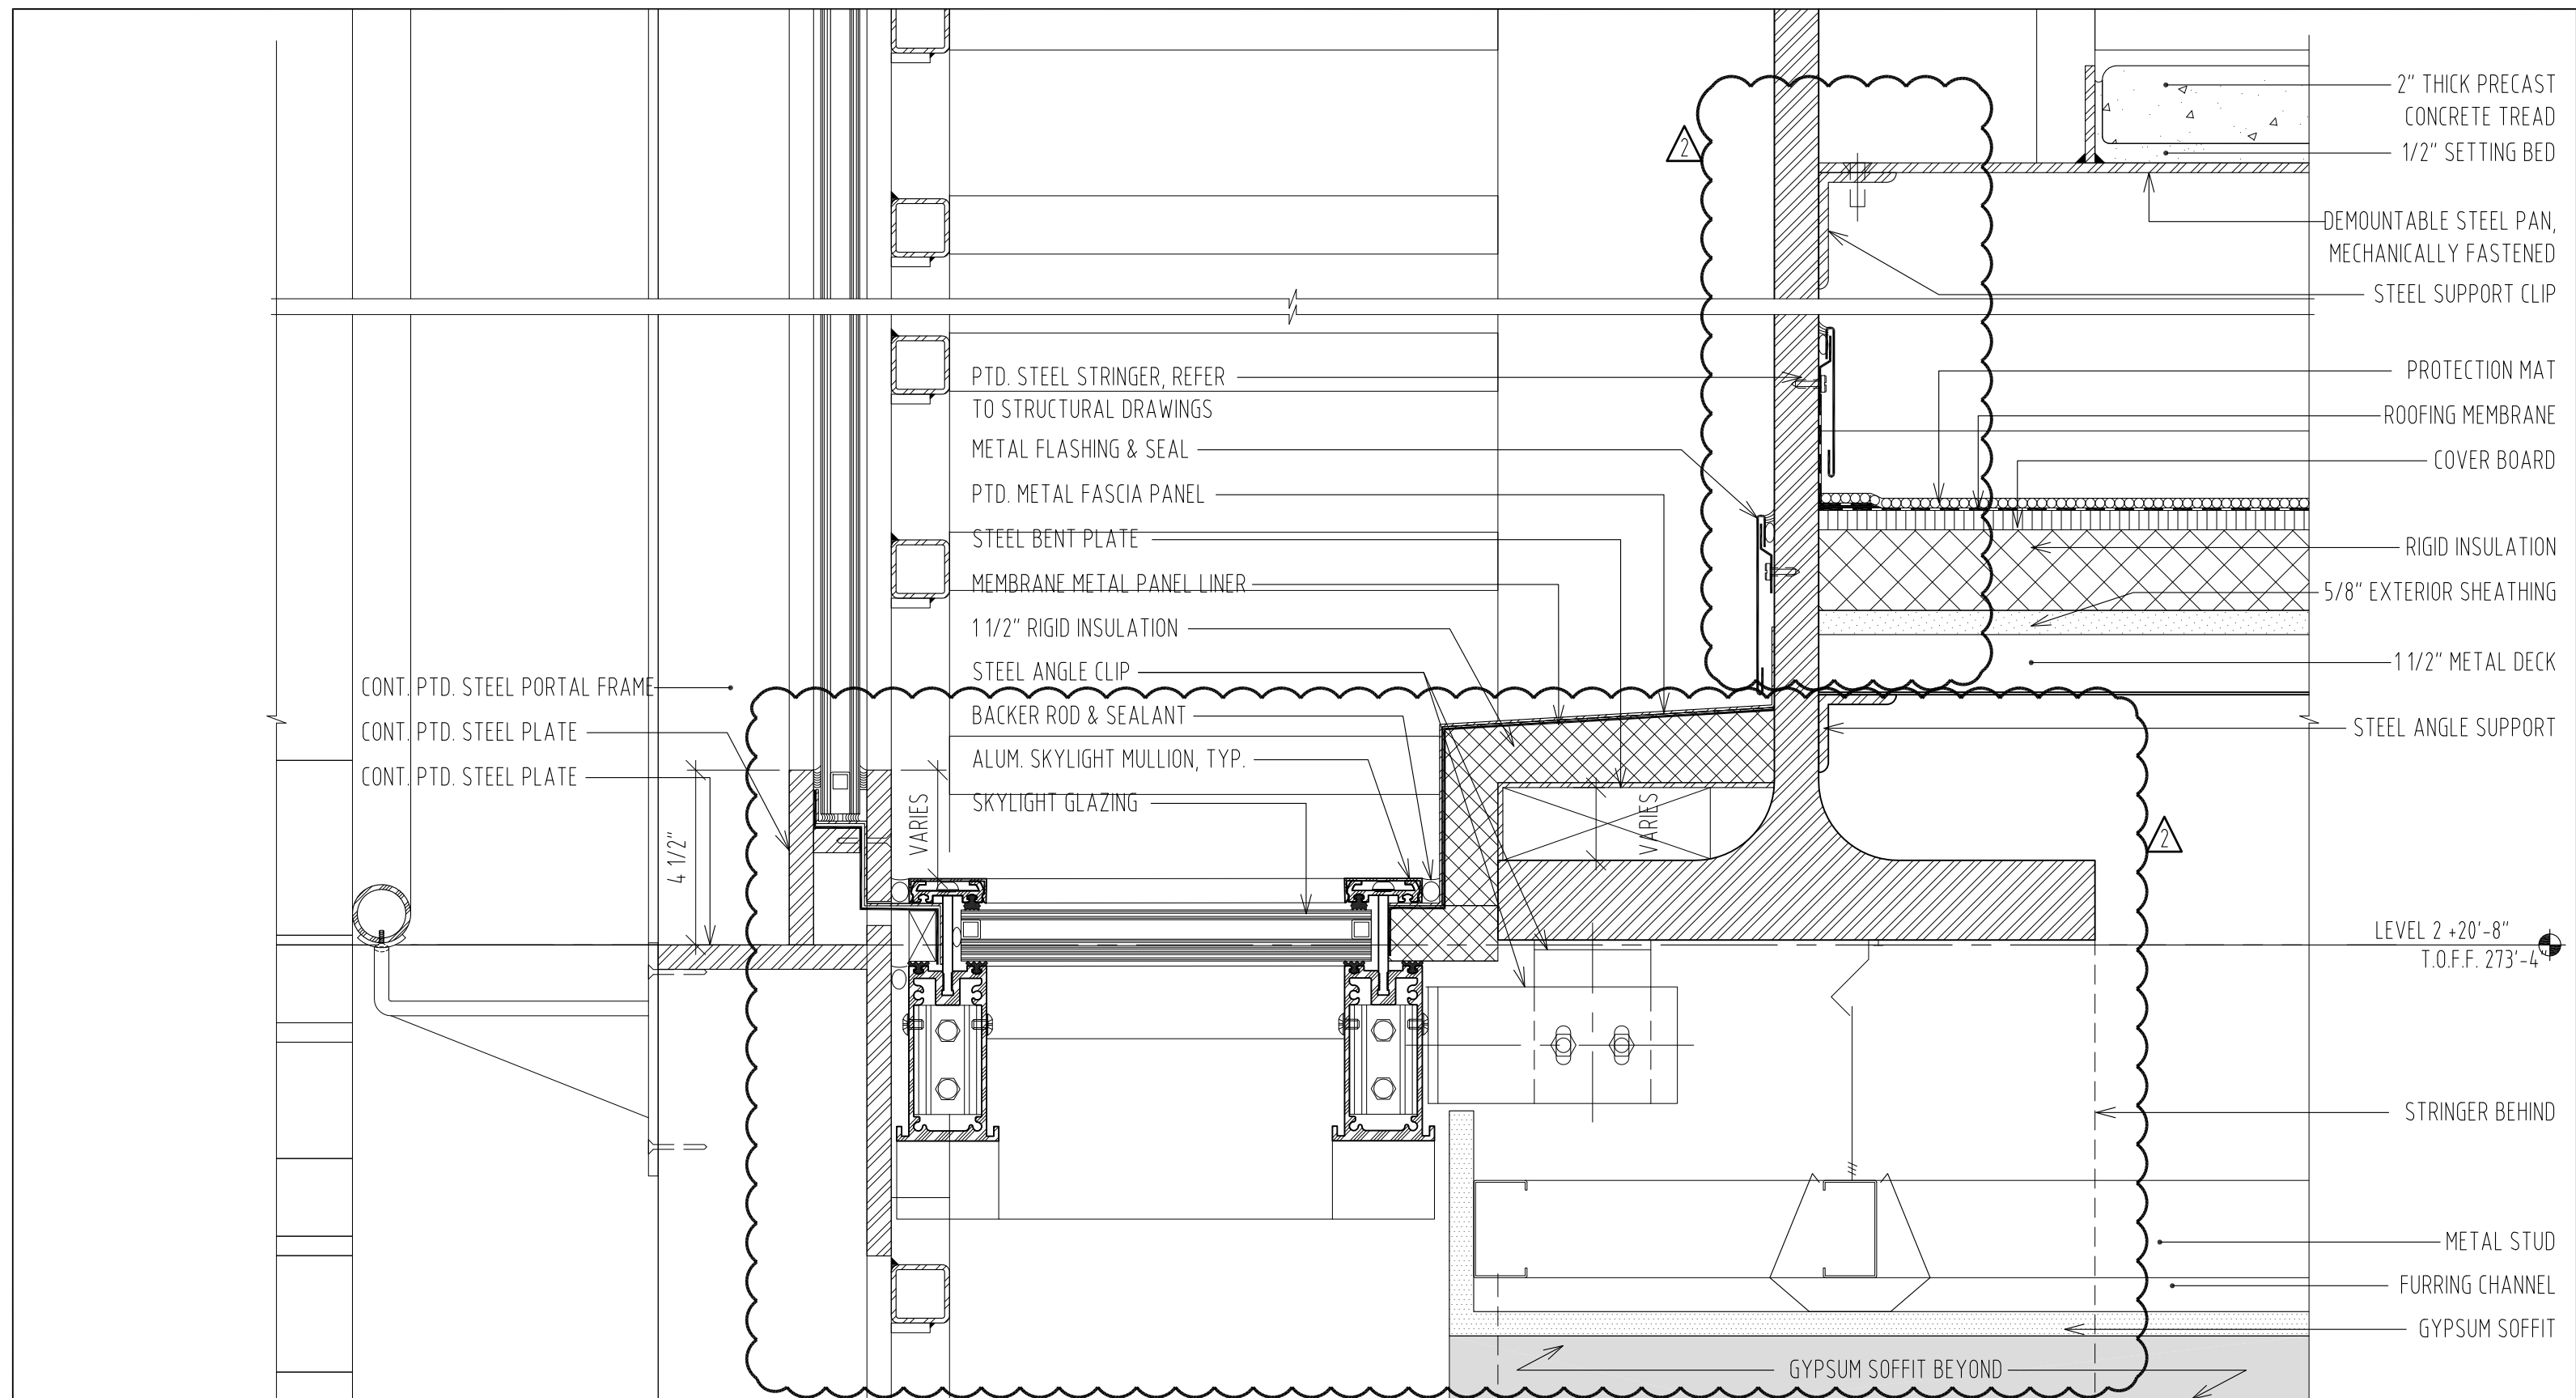

CONT. PTD. STEEL PORTAL FRAME
 CONT. PTD. STEEL PLATE
 CONT. PTD. STEEL PLATE

PTD. STEEL STRINGER, REFER
 TO STRUCTURAL DRAWINGS
 METAL FLASHING & SEAL
 PTD. METAL FASCIA PANEL

STEEL BENT PLATE
 MEMBRANE METAL PANEL LINER
 1 1/2" RIGID INSULATION

STEEL ANGLE CLIP
 BACKER ROD & SEALANT
 ALUM. SKYLIGHT MULLION, TYP.
 SKYLIGHT GLAZING

2" THICK PRECAST
 CONCRETE TREAD
 1/2" SETTING BED

DEMOUNTABLE STEEL PAN,
 MECHANICALLY FASTENED
 STEEL SUPPORT CLIP

PROTECTION MAT
 ROOFING MEMBRANE
 COVER BOARD

RIGID INSULATION
 5/8" EXTERIOR SHEATHING

1 1/2" METAL DECK
 STEEL ANGLE SUPPORT

LEVEL 2 +20'-8"
 T.O.F.F. 273'-4"

STRINGER BEHIND

METAL STUD
 FURRING CHANNEL
 GYPSUM SOFFIT

GYPSUM SOFFIT BEYOND


STAIR 5 (STAIR 6 OPPOSITE) SKYLIGHT DETAIL
 SCALE 3" = 1'-0" 01

MOORE SCHOOL OF BUSINESS
 UNIVERSITY OF SOUTH CAROLINA
 BID PACKAGE 3
 ENCLOSURE/SITE/MEPFP/INTERIOR
 ADDENDUM #003
 PROJECT NO. 655.000

^ ^
 2012.06.22
 RAFAEL VINOLY ARCHITECTS PC

GRAND STAIR DETAIL REVISION _02
 REF. DWG # 02/A4430
 SHEET TITLE :

SCALE :
 3" = 1'-0"
 SHEET NUMBER :
 A-SK-089

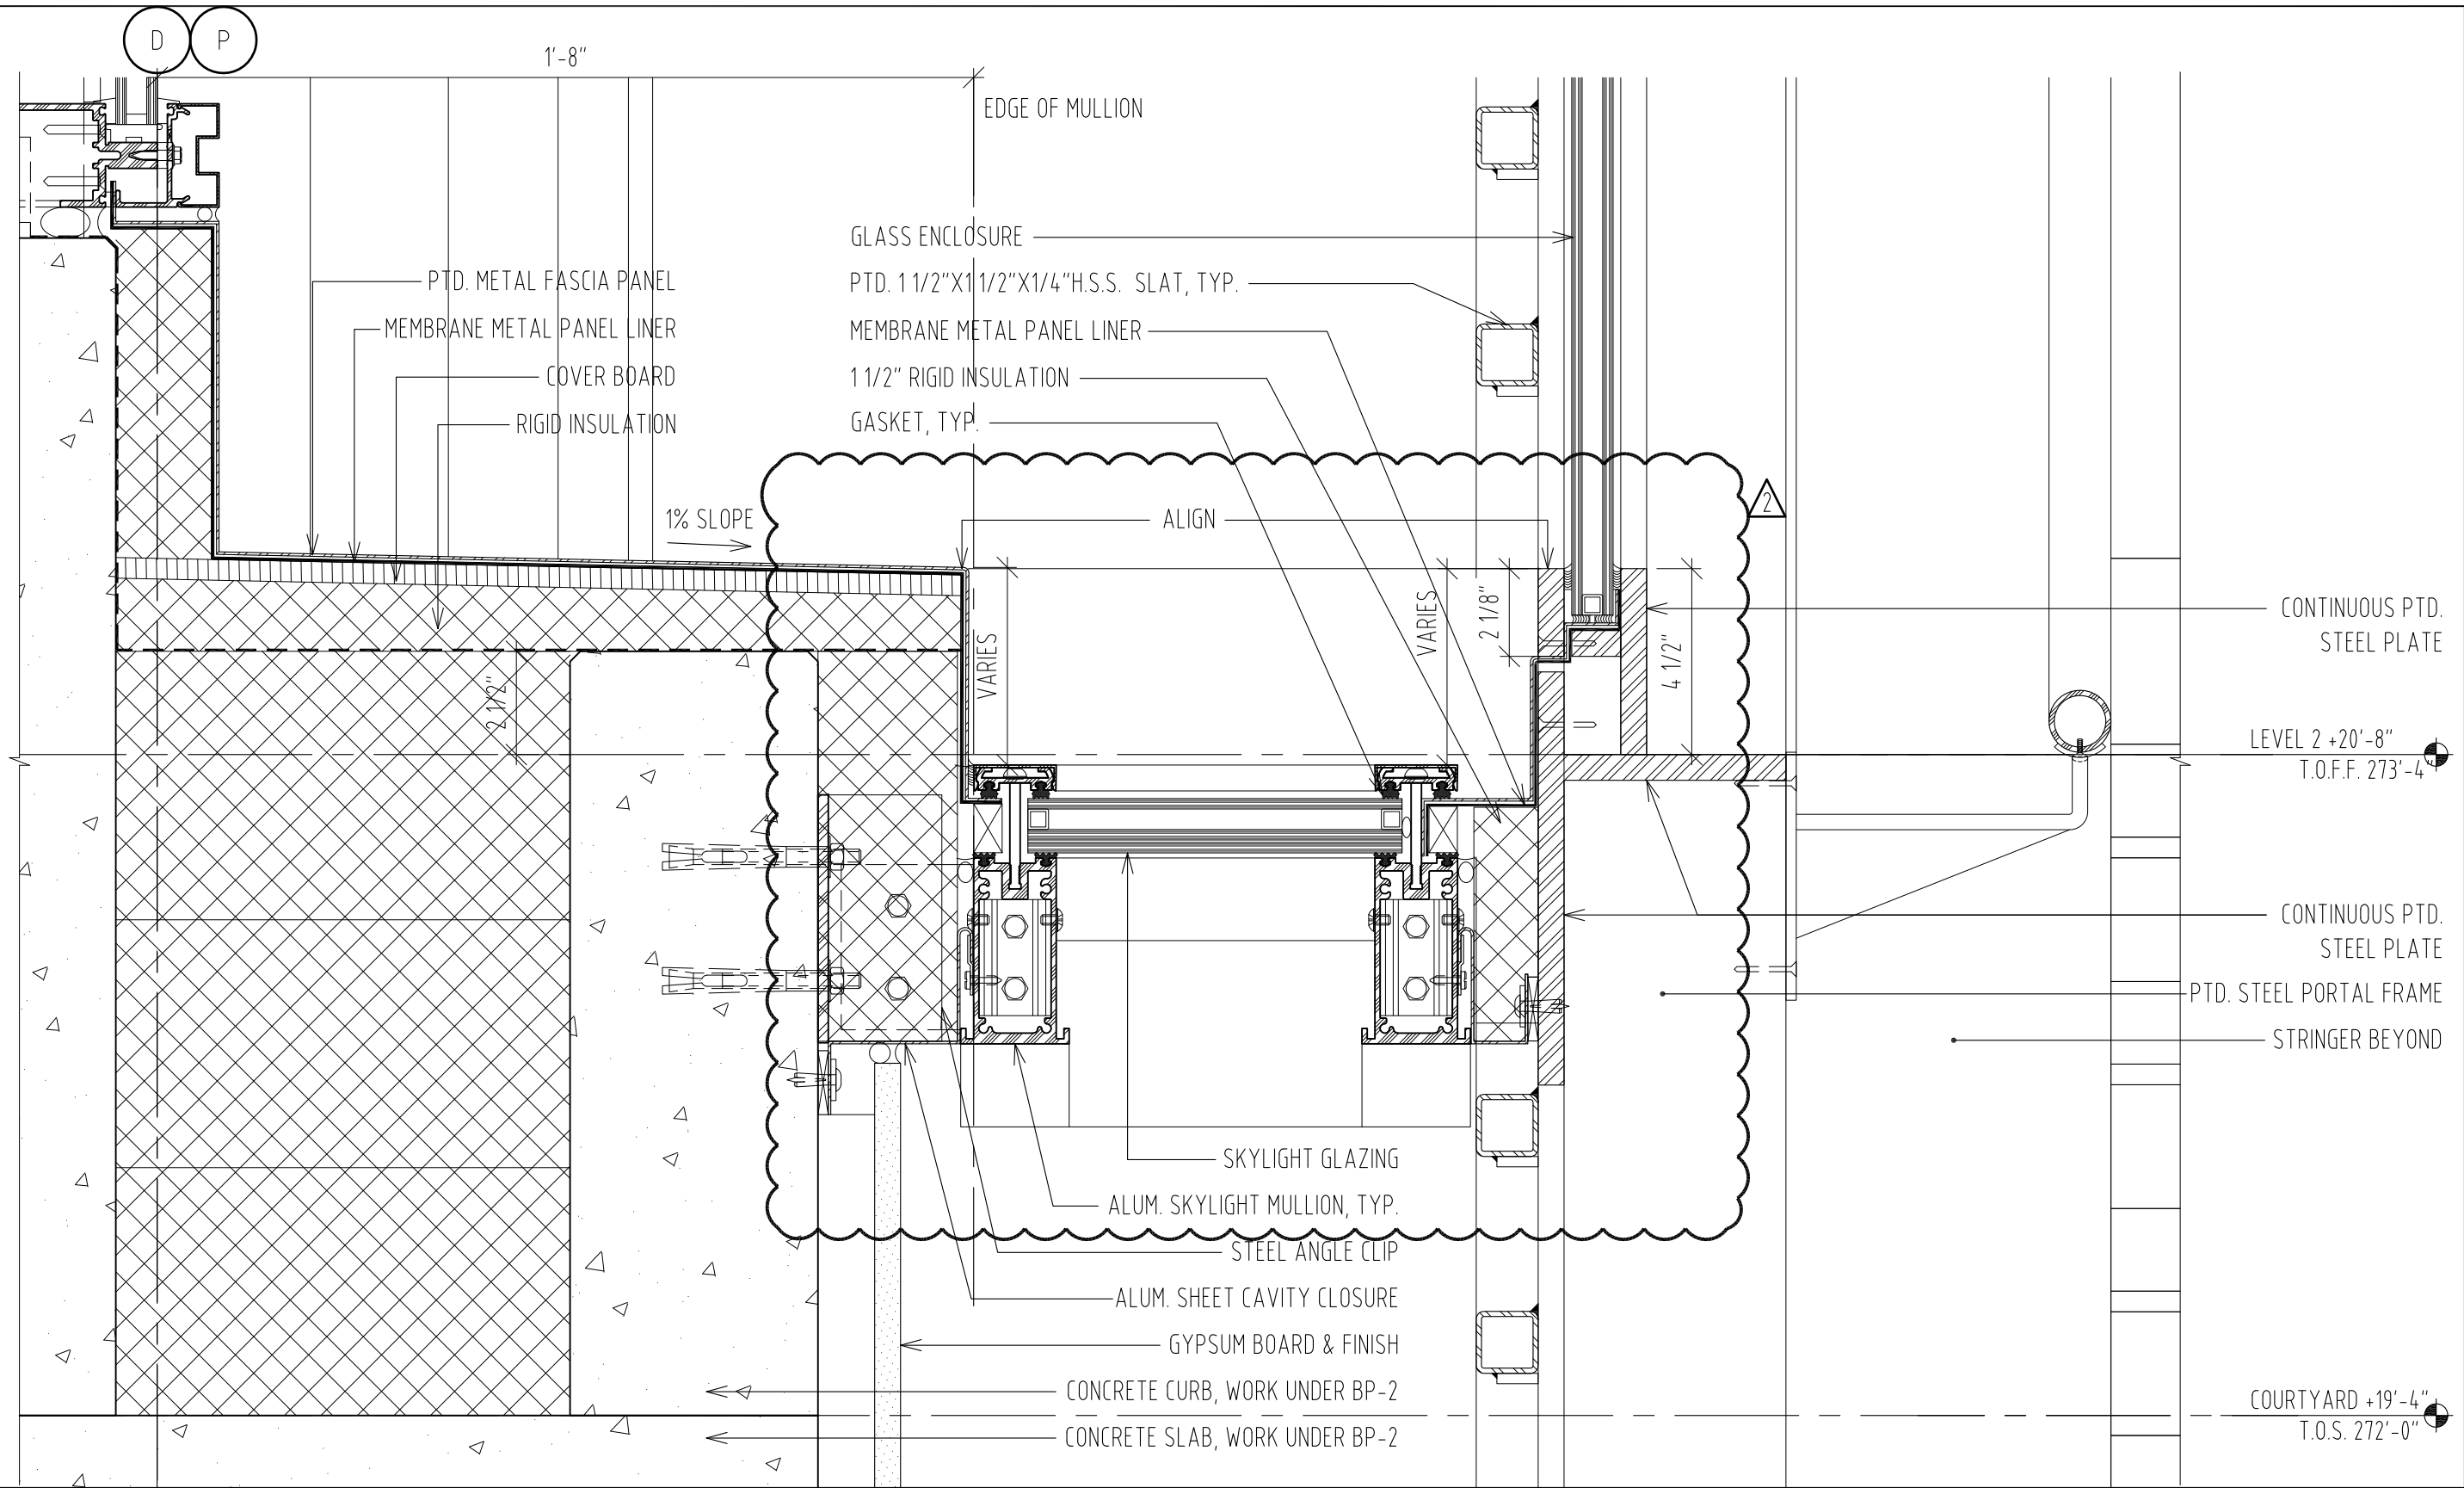


MOORE SCHOOL OF BUSINESS
 UNIVERSITY OF SOUTH CAROLINA
 BID PACKAGE 3
 ENCLOSURE/SITE/MEFP/INTERIOR
 ADDENDUM #003
 PROJECT NO. 655.000

^ ^
 — —
 ^ ^
 — —
 2012.06.22
 © RAFAEL VINOLY ARCHITECTS PC

GRAND STAIR DETAIL REVISION 03
 REF. DWG # 03/A4430
 SHEET TITLE :

STAIR 5 (STAIR 6 OPPOSITE) SKYLIGHT DETAIL
 SCALE 3" = 1'-0" 01

SCALE :
 3" = 1'-0"
 SHEET NUMBER :
 A-SK-090

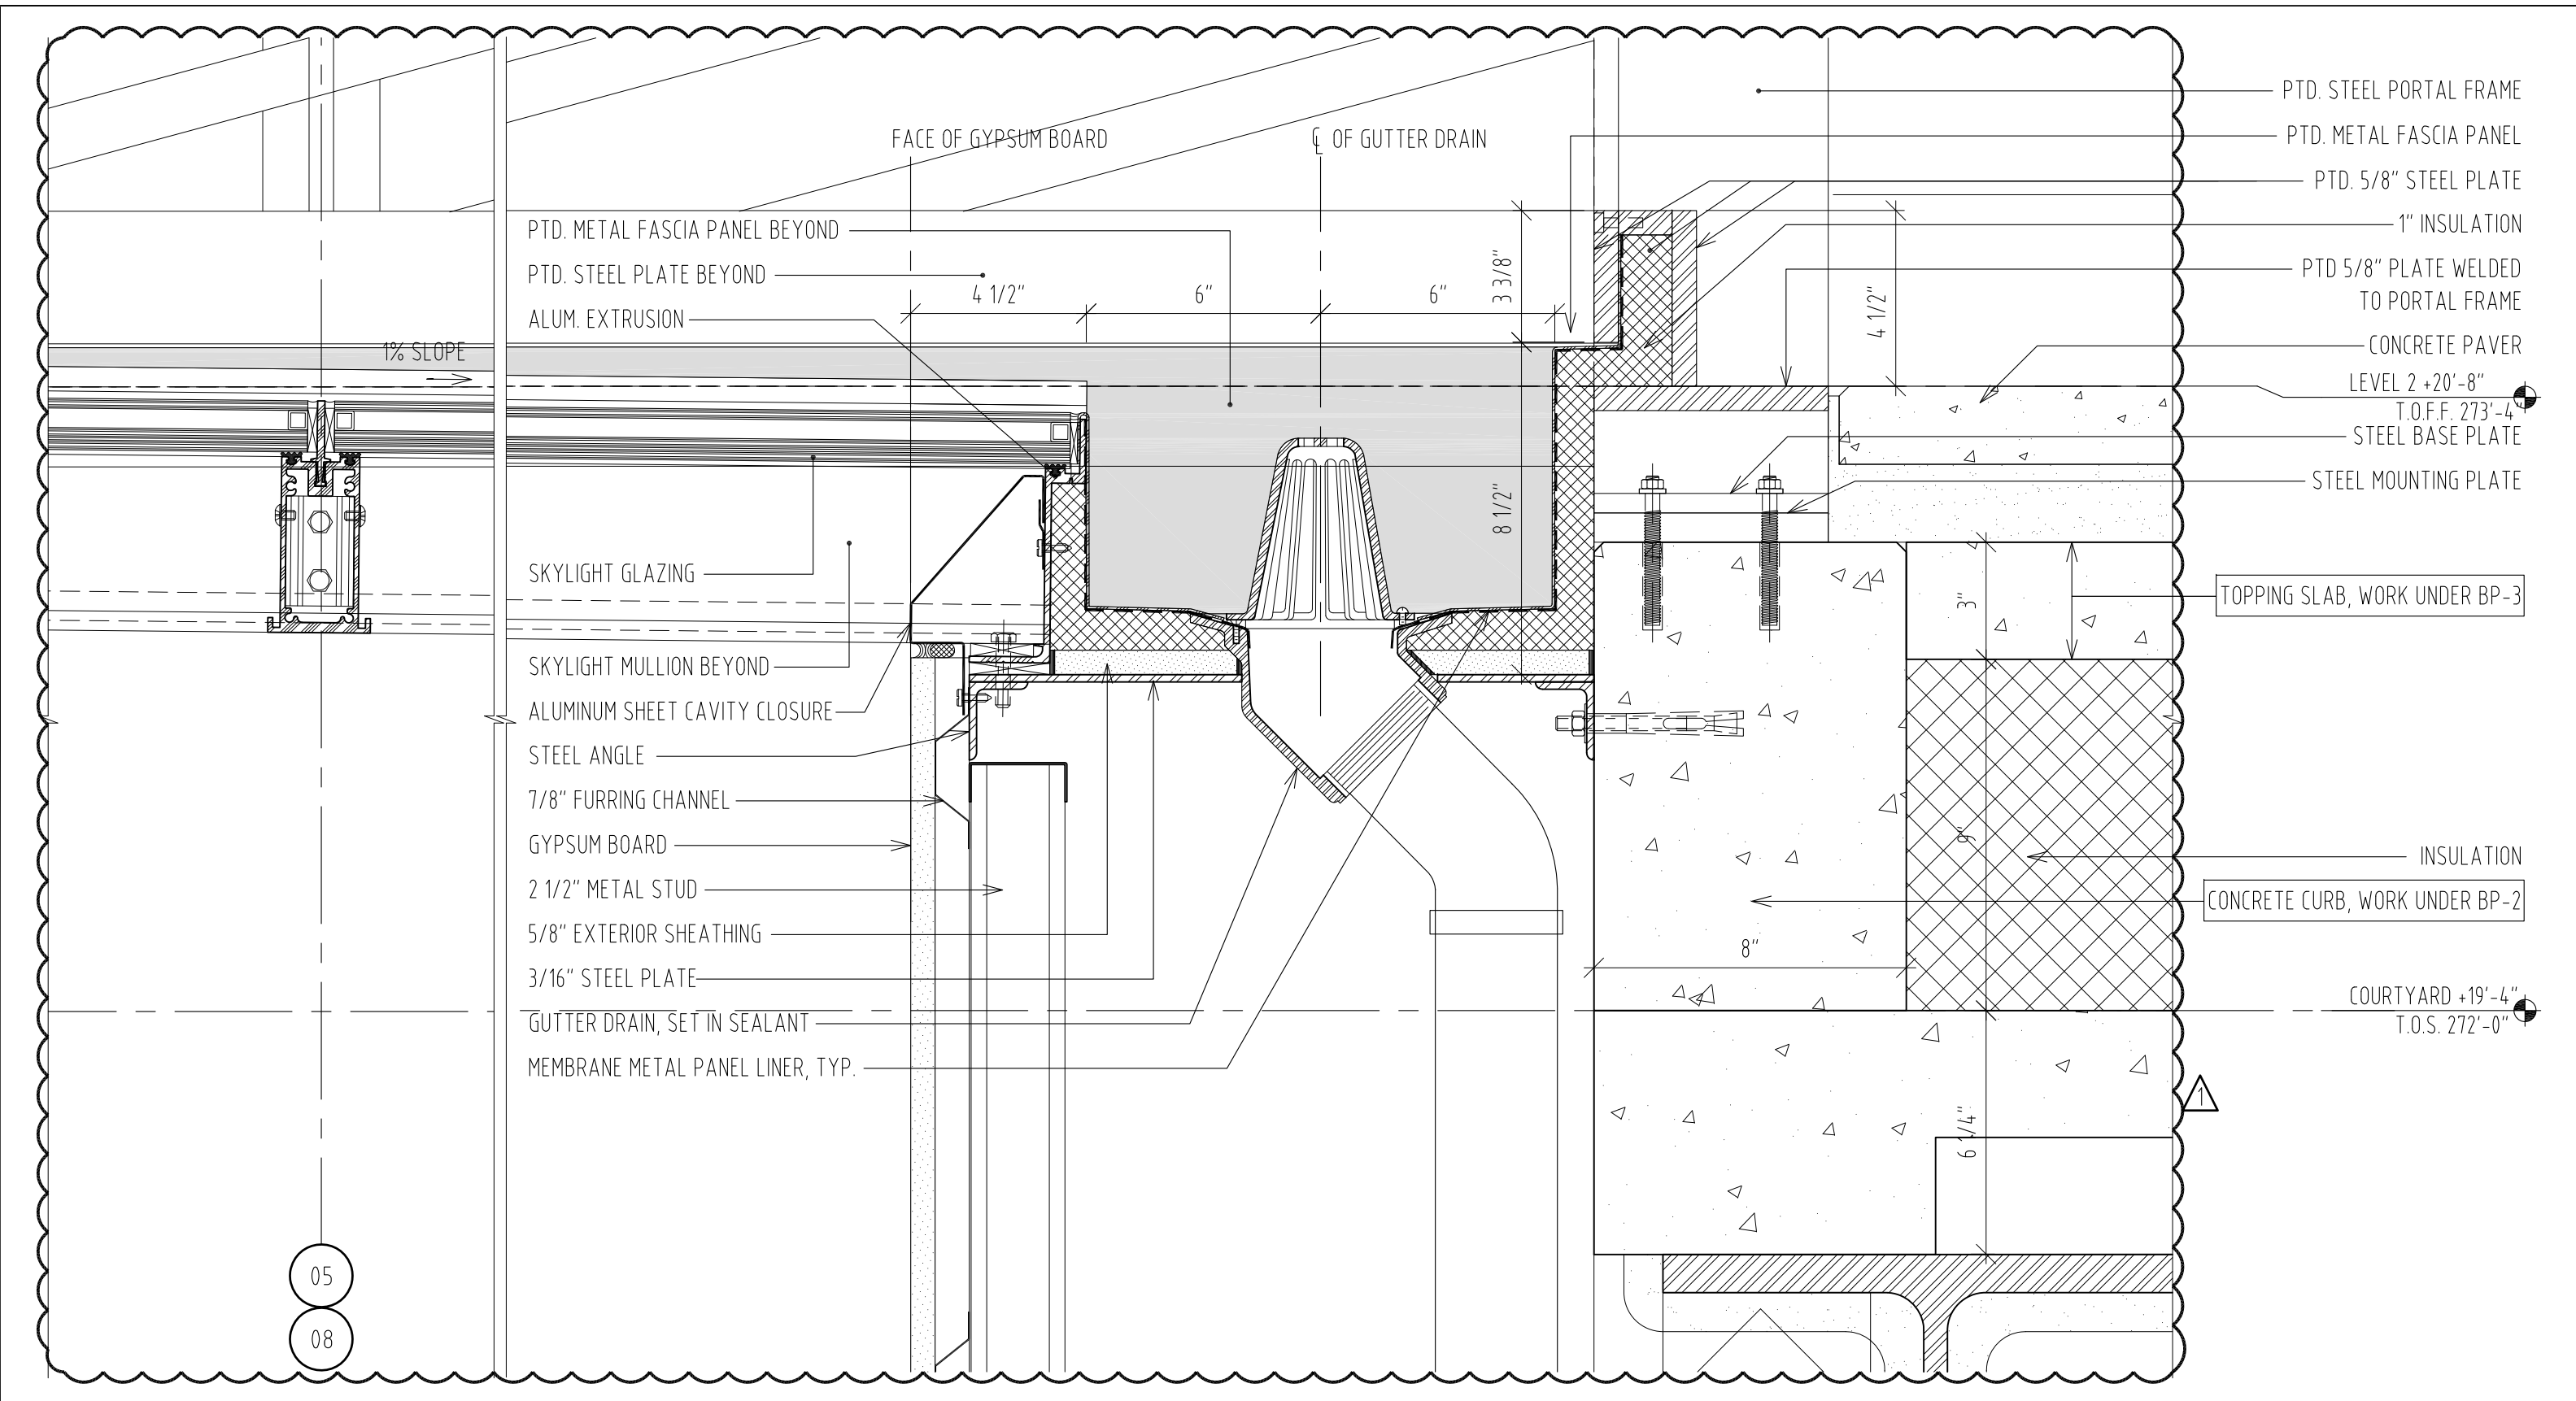

05
08


STAIR 5 (STAIR 6 OPPOSITE) SKYLIGHT GUTTER DRAIN DETAIL
SCALE 3" = 1'-0" 01

MOORE SCHOOL OF BUSINESS
UNIVERSITY OF SOUTH CAROLINA
BID PACKAGE 3
ENCLOSURE/SITE/MEFP/INTERIOR
ADDENDUM #003
PROJECT NO. 655.000

2012.06.22
© RAFAEL VINOLY ARCHITECTS PC


SKYLIGHT GUTTER DRAIN - DETAIL
REFER TO DWG #01/A4426 FOR PLAN
SHEET TITLE :

SCALE :
3" = 1'-0"
SHEET NUMBER :
A-SK-091

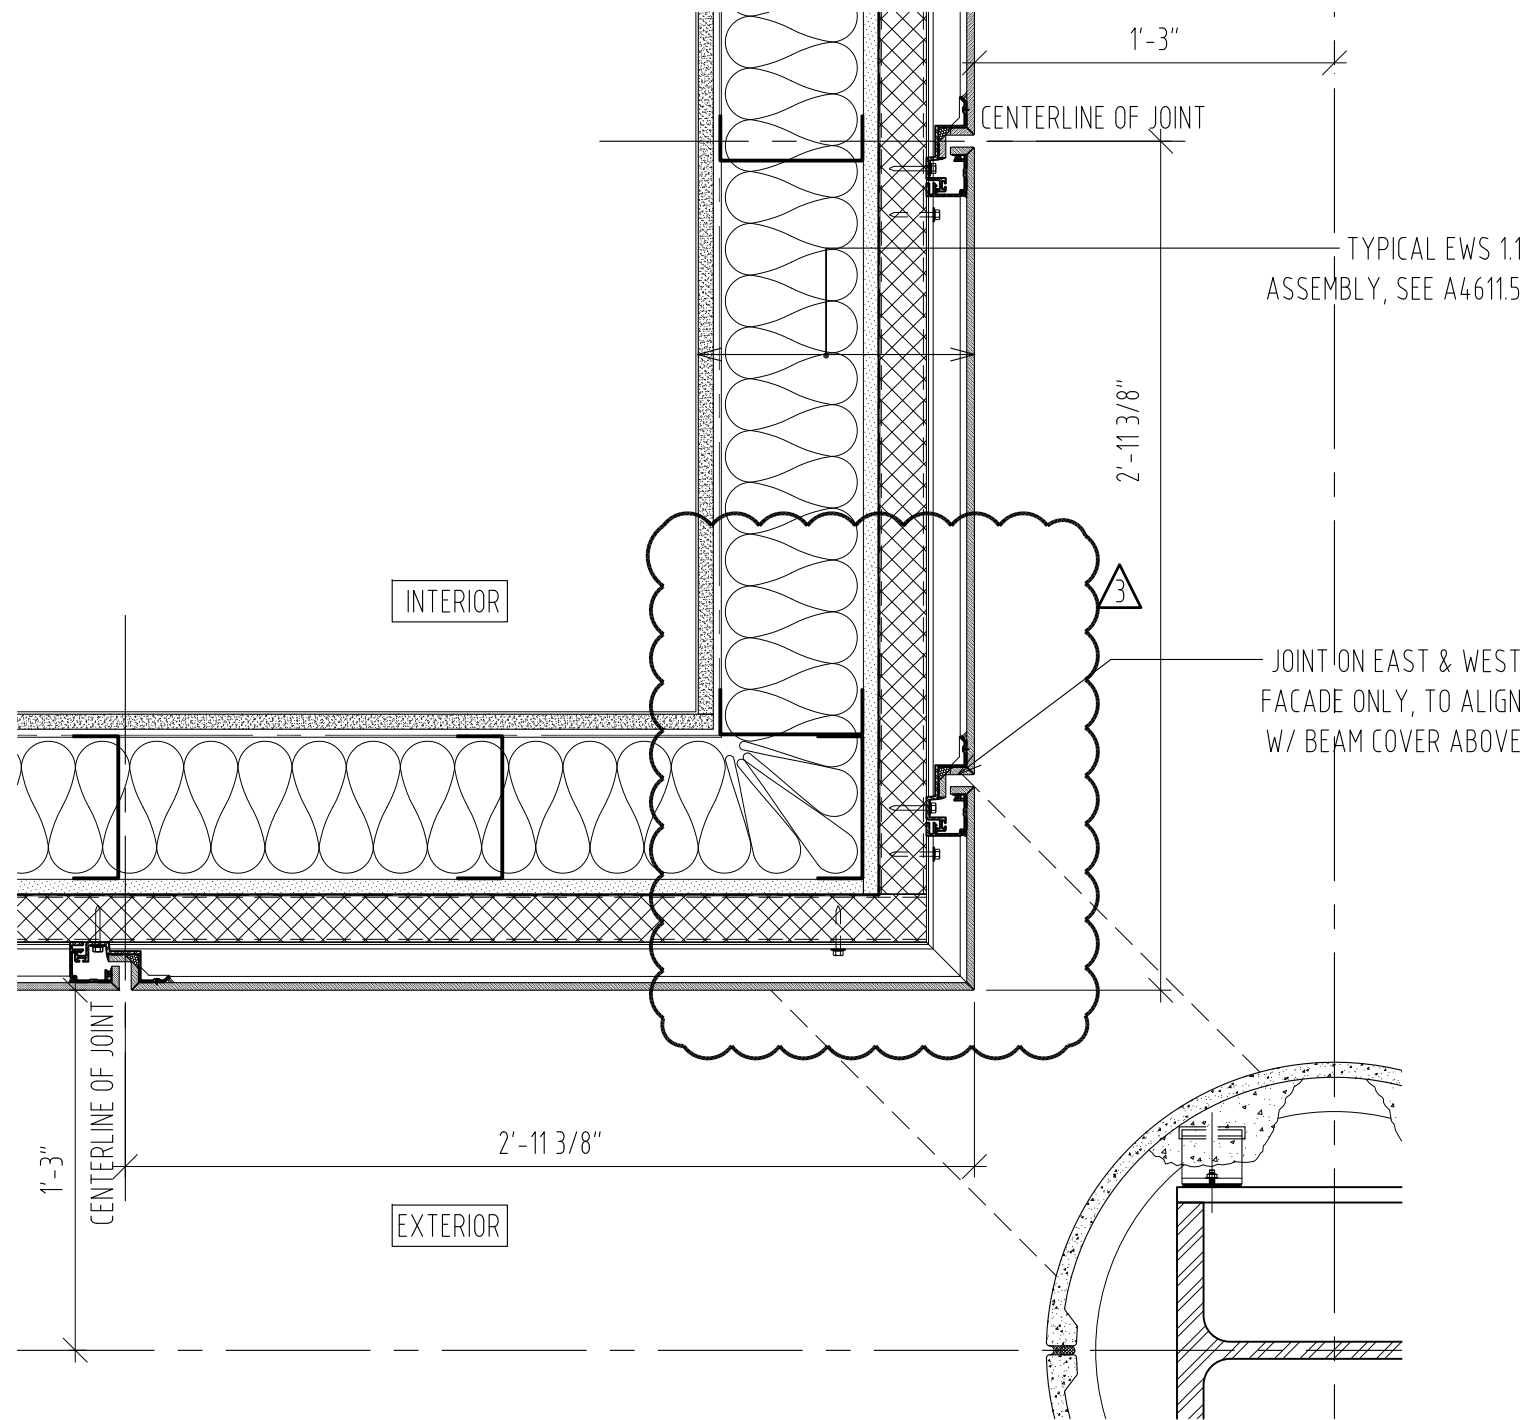

REF. DWG #01/A4611.5

EWS-1.1 DETAIL
SCALE : 1 1/2" = 1'-0" 02

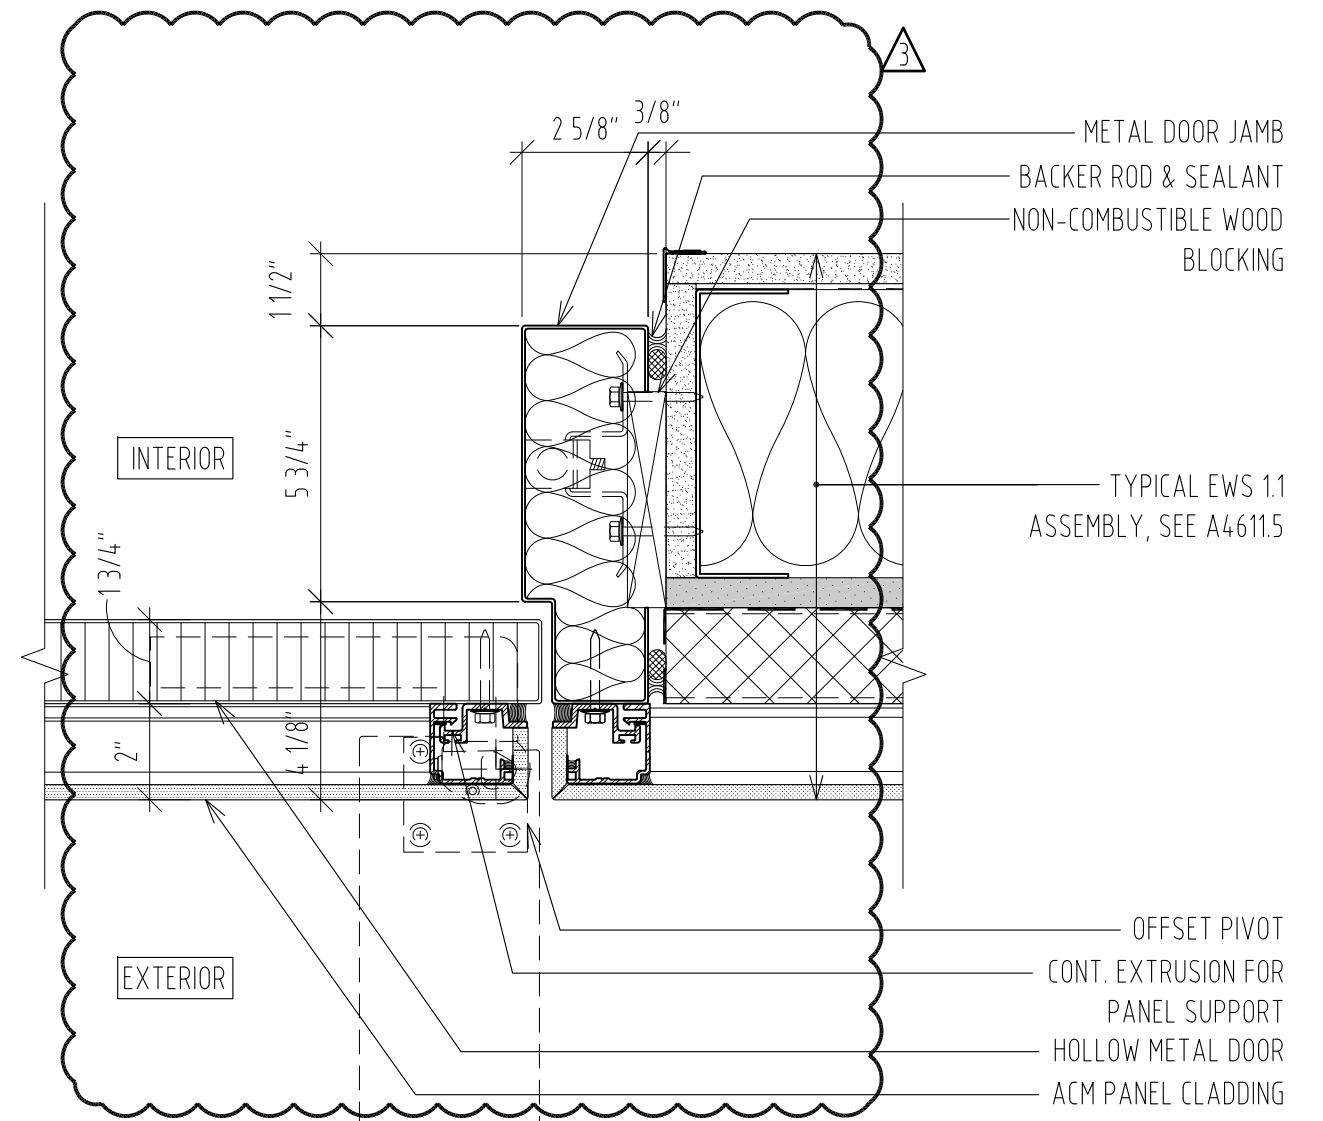

EWS-1.1: H.M. DOOR JAMB DETAIL
SCALE : 3" = 1'-0" 01

MOORE SCHOOL OF BUSINESS
UNIVERSITY OF SOUTH CAROLINA
BID PACKAGE 3
ENCLOSURE/SITE/MEFP/INTERIOR
ADDENDUM #003

PROJECT NO. 655.000


^ ^
2012.06.22
RAFAEL VINOLY ARCHITECTS PC

LEVEL 1 MP-1 DETAIL REVISION
REF. DWG # A4611.5

SHEET TITLE :


SCALE :
REFER TO DRAWING

SHEET NUMBER :
A-SK-092

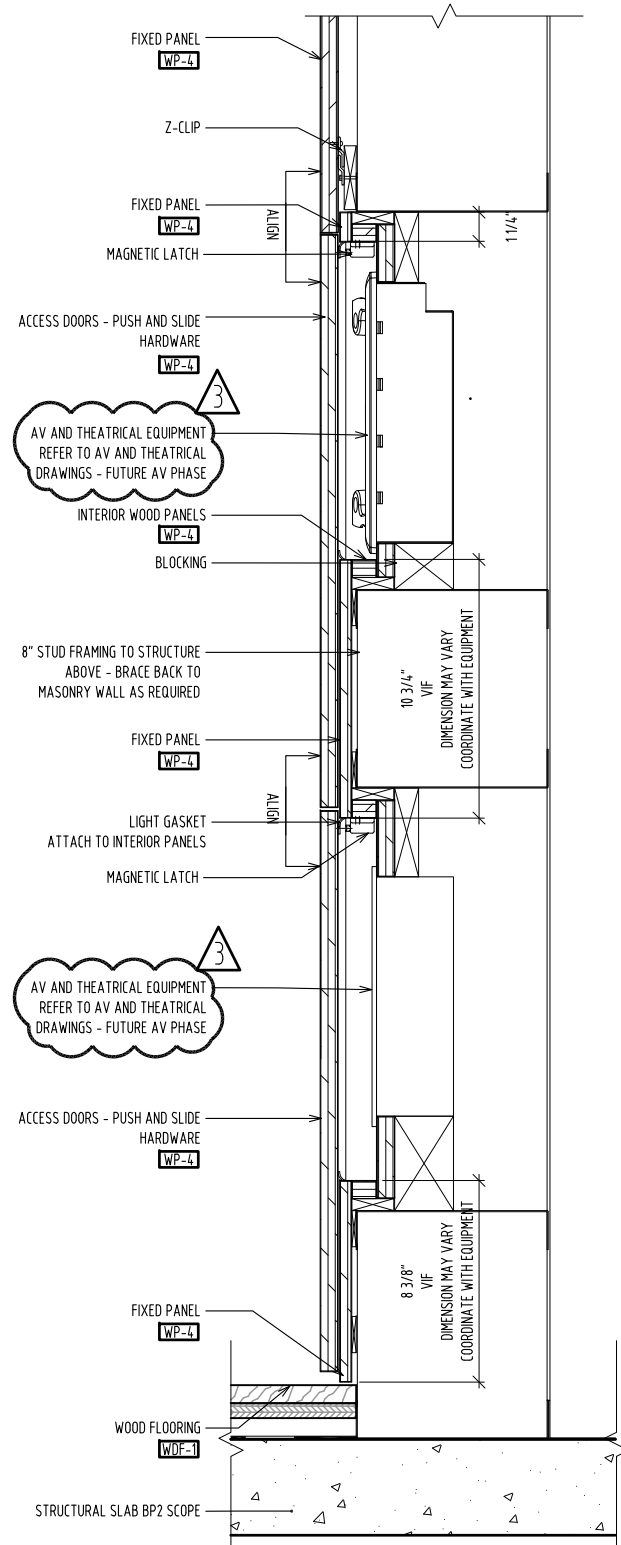


CONTROL PANEL ACCESS SECTION @ STAGE 05
SCALE: 1.5" = 1'-0"

03

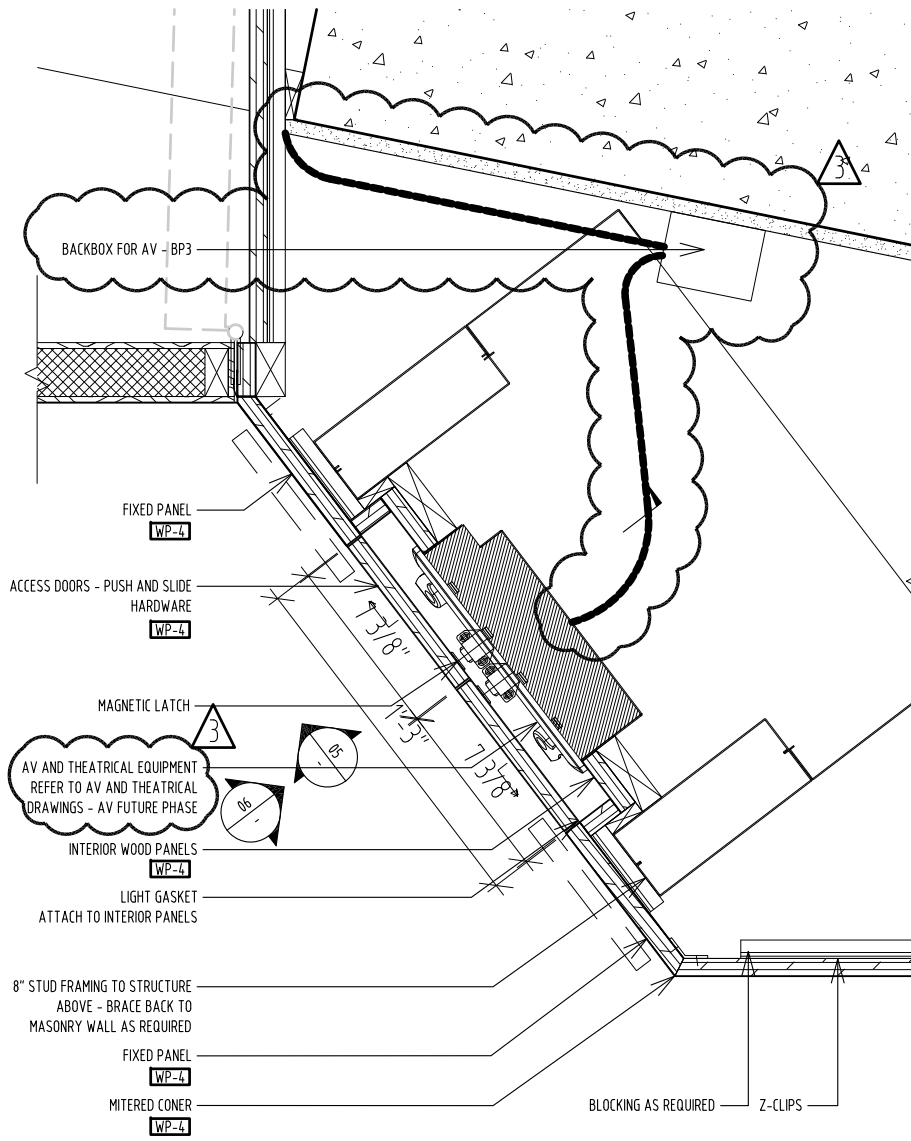


TORMENTOR LIGHTING ACCESS PANEL 03
SCALE: 1.5" = 1'-0"

02

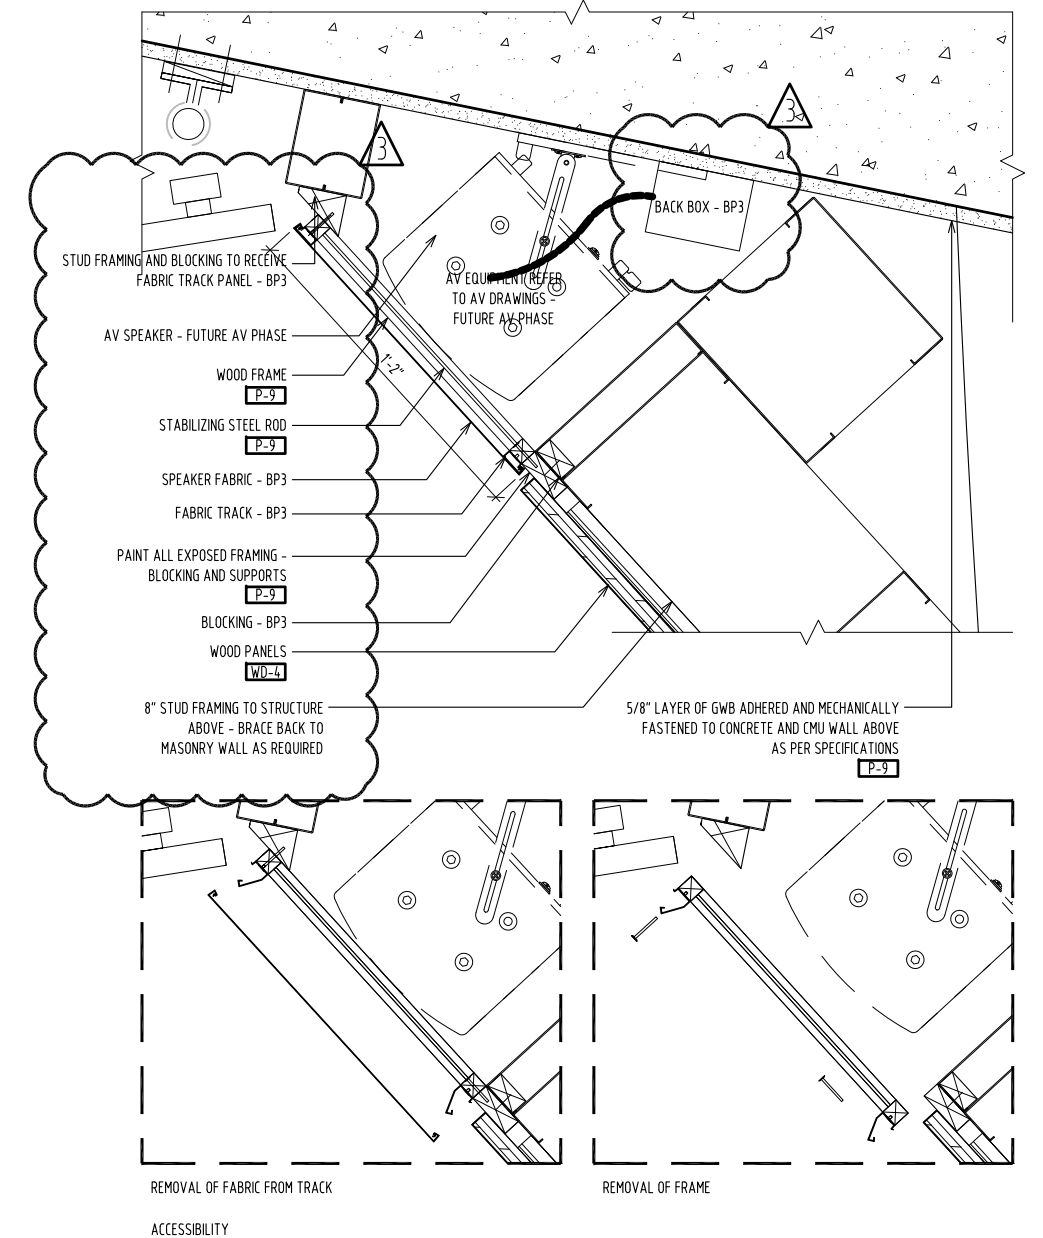

TORMENTOR LIGHTING ACCESS PANEL 02
SCALE: 3" = 1'-0"


01

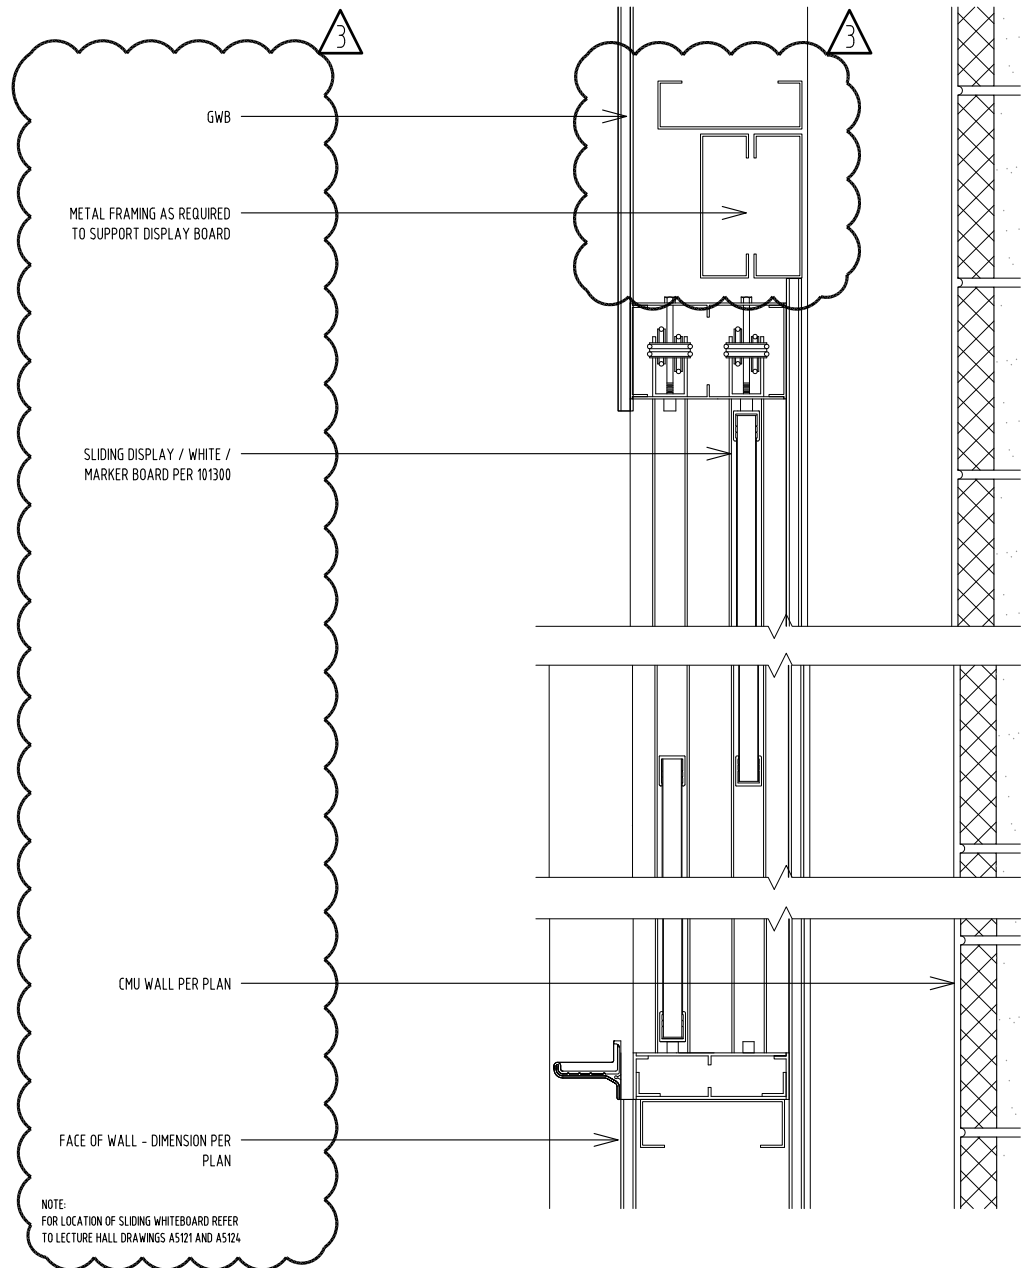

LECTURE HALL SLIDING WHITEBOARD DETAILS 05

1.5" = 1'-0"

02

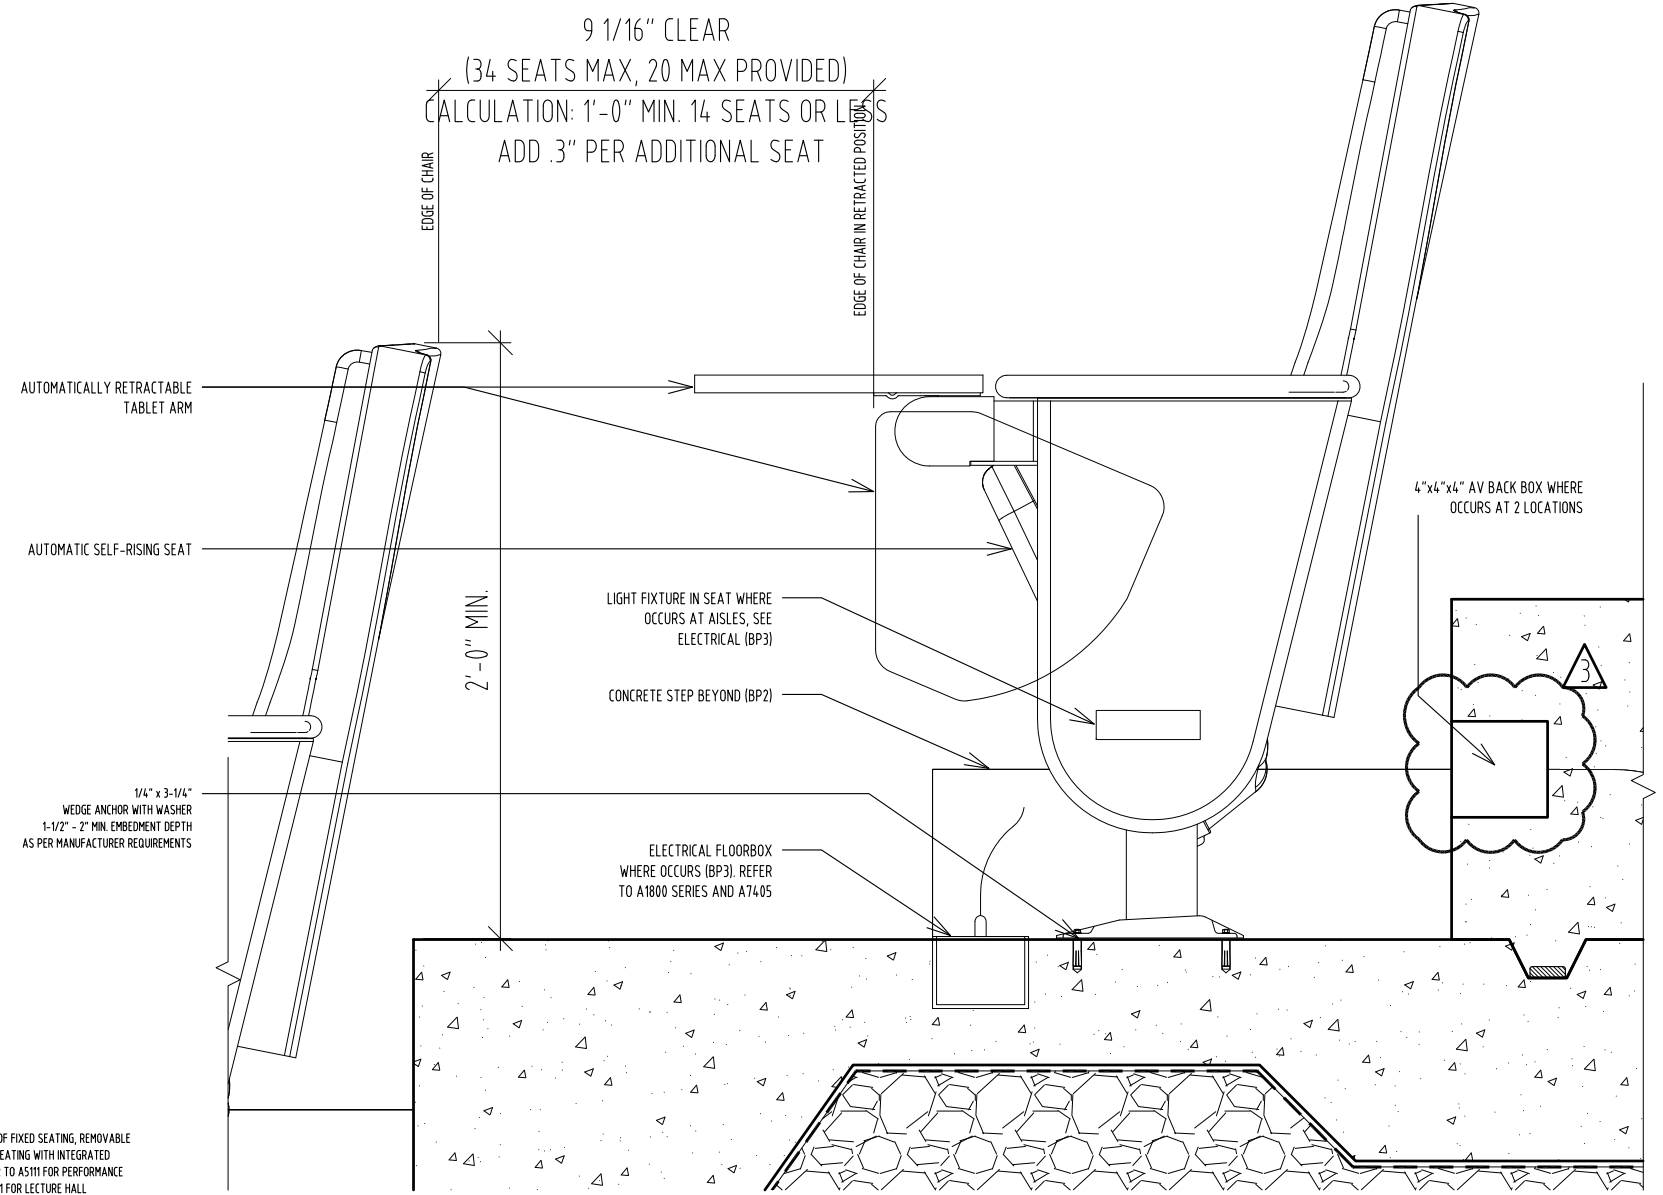

PERFORMANCE HALL FIXED SEATING 01

SCALE: 1.5" = 1'-0"


01

MOORE SCHOOL OF BUSINESS
UNIVERSITY OF SOUTH CAROLINA
BID PACKAGE 3
ENCLOSURE/SITE/MEPFP/INTERIOR
ADDENDUM #003
PROJECT NO. 655.000

^ ^
2012.06.22
© RAFAEL VINOLY ARCHITECTS PC

SEATING DETAILS PERFORMANCE HALL & LECTURE HALL
REF. DWG #A7017
SHEET TITLE :

SCALE :
1 1/2" = 1'-0"
SHEET NUMBER :
A-SK-095

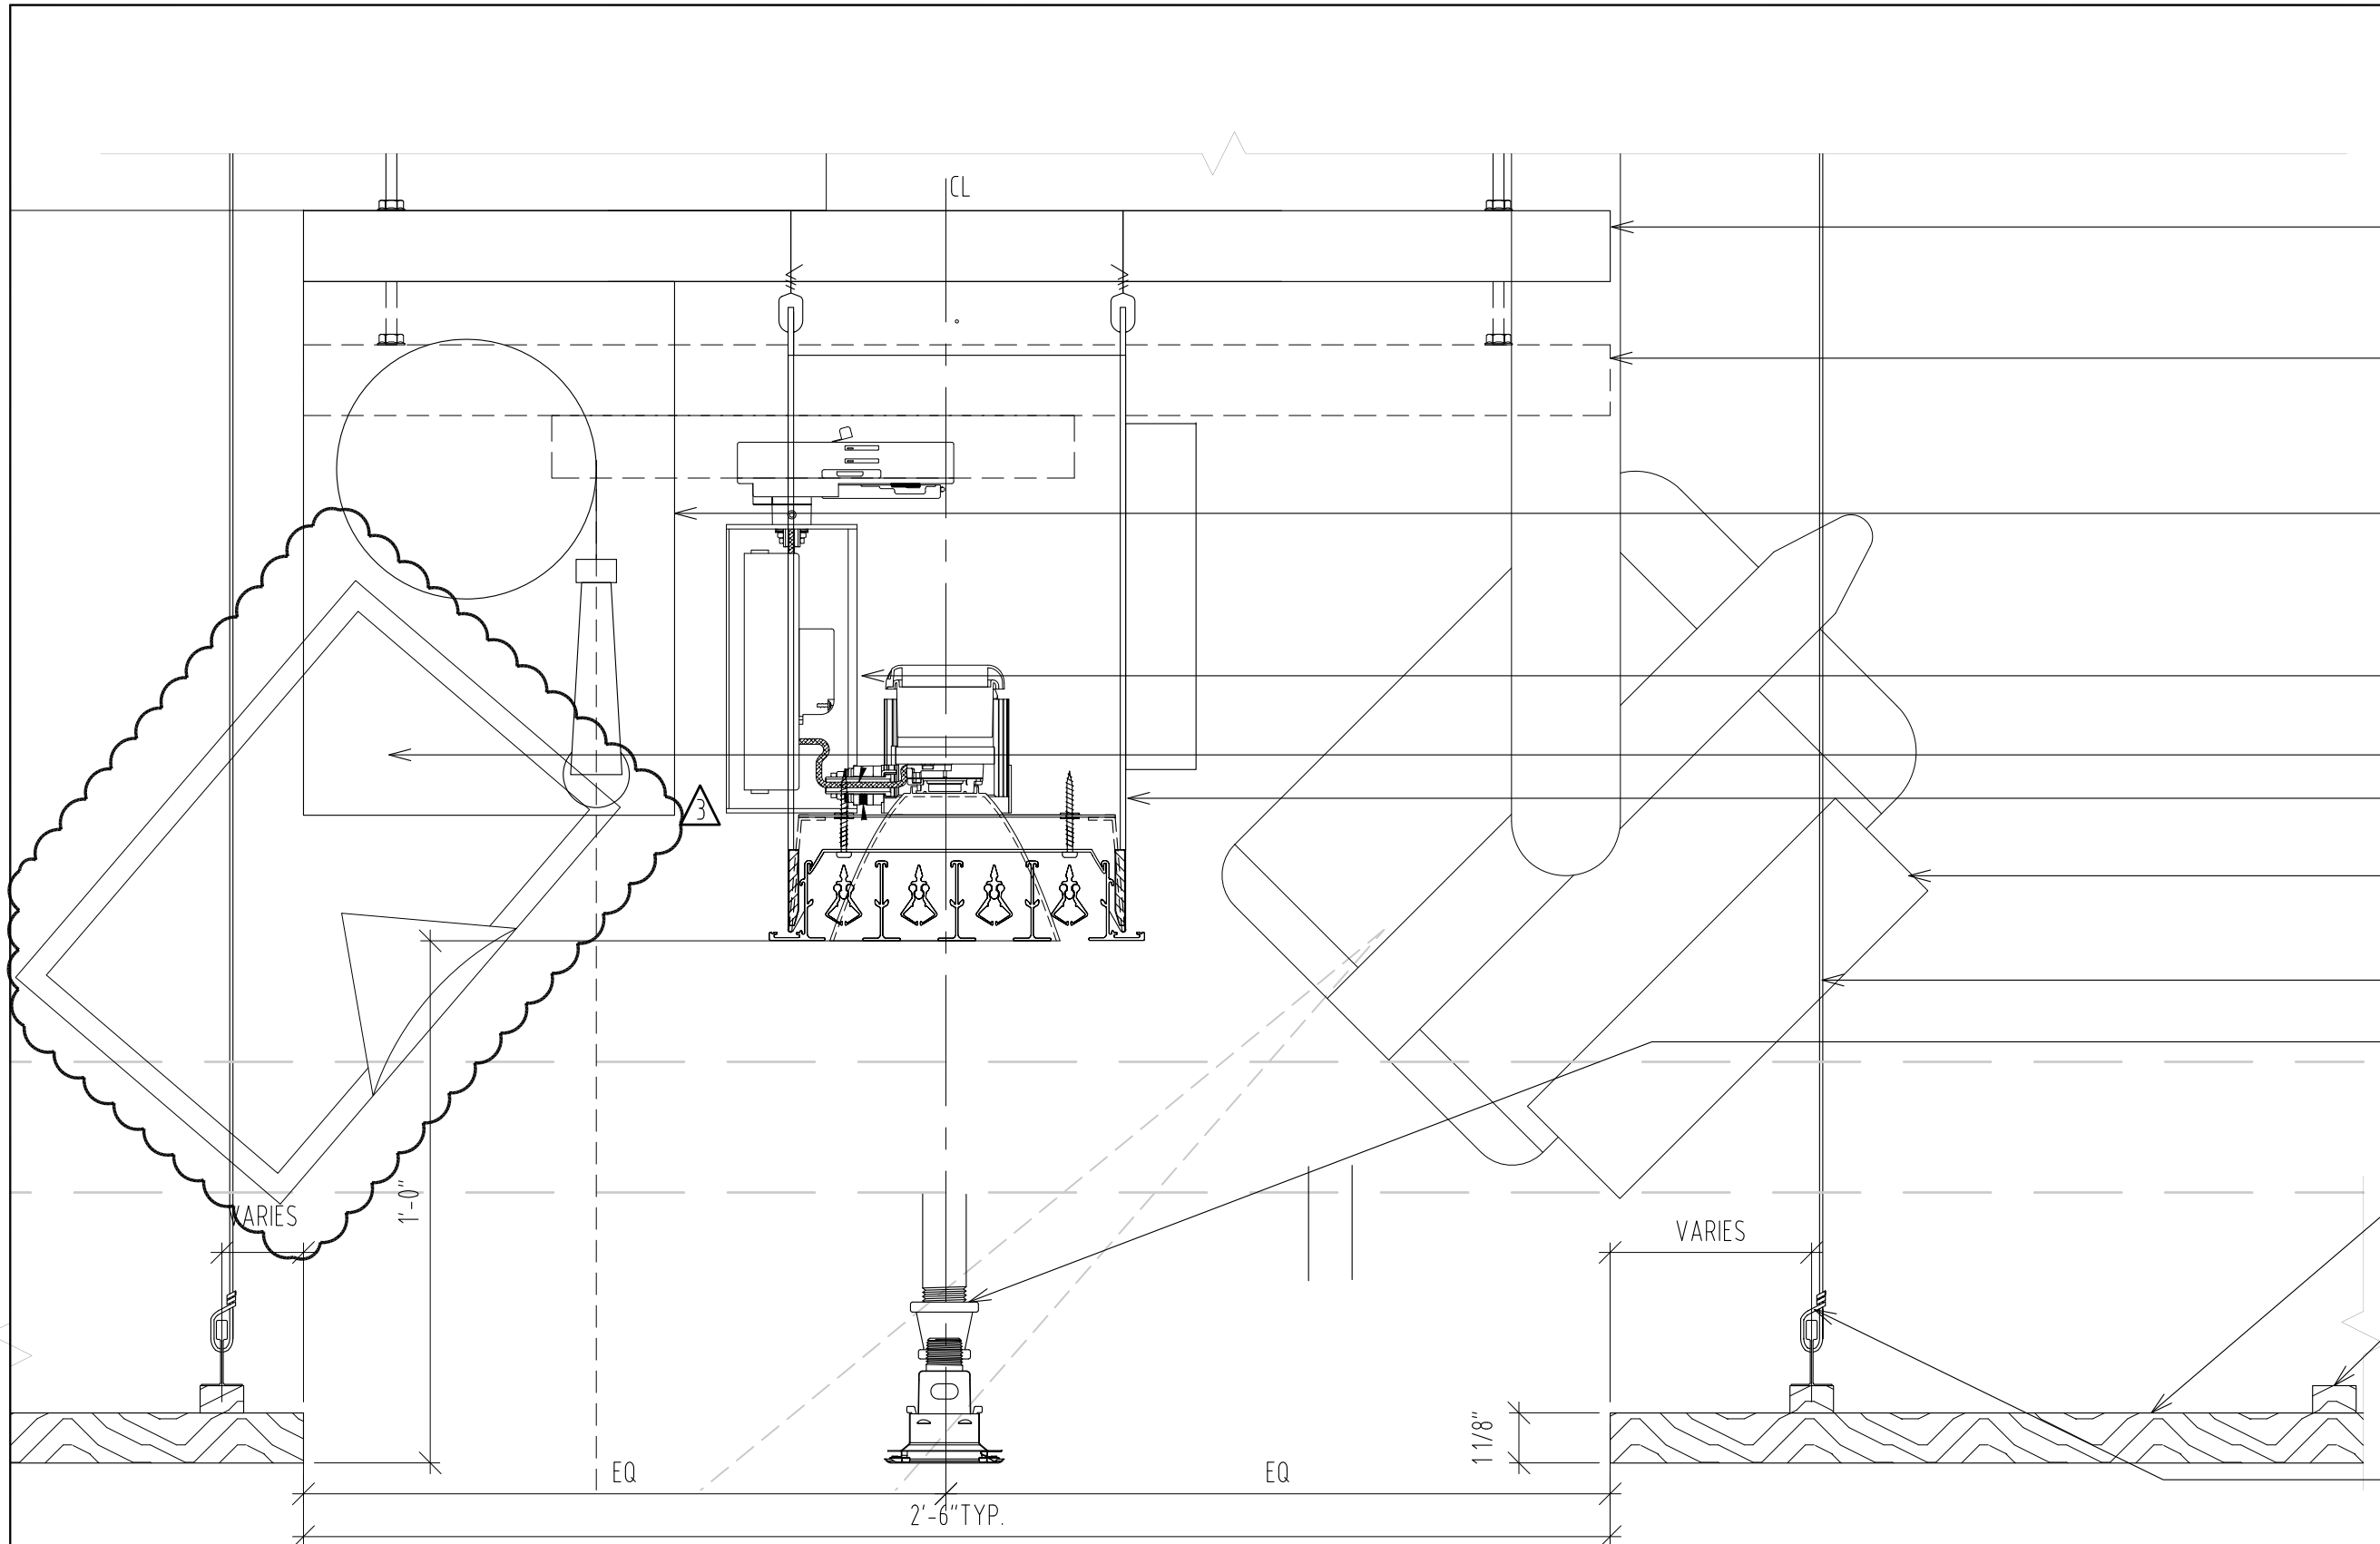

- 3 ALL EQUIPMENT, FASTENERS AND SURFACES ABOVE FINISHED CEILING TO BE PAINTED OR HAVE FACTORY FINISH TO MATCH P-9
- STEEL CHANNEL PERPENDICULAR TO WOOD SLAT CURVE - FASTENED TO STRUCTURE ABOVE FOR HVAC DIFFUSERS - BP3
- STEEL CHANNEL PERPENDICULAR TO WOOD SLAT CURVE - FASTENED TO STRUCTURE ABOVE FOR ARCHITECTURAL LIGHTING - BP3
- AV MOTORIZED MICROPHONES REFER TO AV DRAWINGS - COORDINATE LOCATION WITH THEATER LIGHTING ANGLES AND SCREEN PROJECTION - FUTURE AV PHASE
- ARCHITECTURAL LIGHTING REFER TO ELECTRICAL DRAWINGS - BP3
- SOUND SPEAKER - FUTURE AV PHASE
- HVAC DIFFUSERS REFER TO MECHANICAL DRAWINGS
- THEATER LIGHTING REFER TO THEATER DRAWINGS - BP3
- HANGER WIRE - BP3
- SPRINKLER HEAD TYP. REFER TO PLAN FOR LOCATION. REFER TO FIRE PROTECTION DRAWINGS FOR LAYOUT ABOVE FLOATING CEILING - BP3
- WOOD SLAT PANELS - BP3
WP-3
- WOOD BACKED PANEL 12" O.C. - BP3
P-9

TEE SUSPENSION SYSTEM
INSTALL AS PER MANUFACTURER


WOOD SLAT CEILING PANELS DETAIL SECTION 02
SCALE : 3" = 1'-0" 01

MOORE SCHOOL OF BUSINESS
UNIVERSITY OF SOUTH CAROLINA
BID PACKAGE 3
ENCLOSURE/SITE/MEPFP/INTERIOR
ADDENDUM #003
PROJECT NO. 655.000

^ ^
2012.06.22
© RAFAEL VINOLY ARCHITECTS PC

CEILING DETAILS PERFORMANCE HALL
REF. DWG #A7106
SHEET TITLE :

SCALE :
3" = 1'-0"
SHEET NUMBER :
A-SK-096

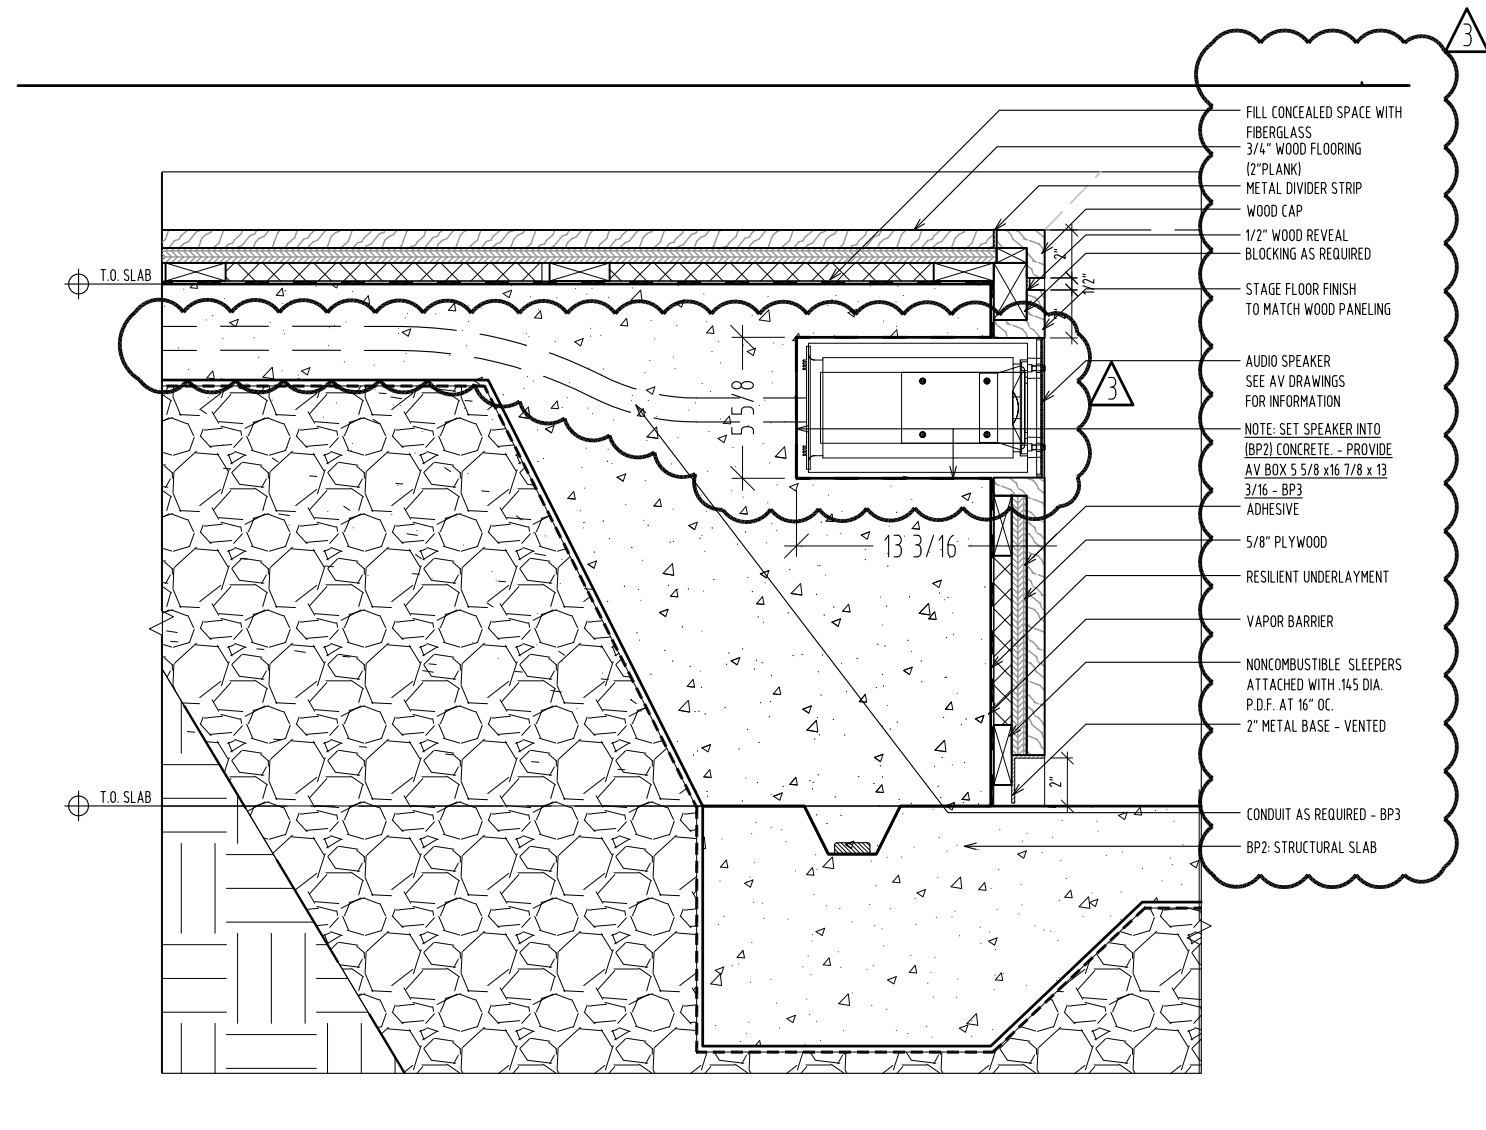

- FILL CONCEALED SPACE WITH FIBERGLASS
- 3/4" WOOD FLOORING (2" PLANK)
- METAL DIVIDER STRIP
- WOOD CAP
- 1/2" WOOD REVEAL
- BLOCKING AS REQUIRED
- STAGE FLOOR FINISH TO MATCH WOOD PANELING
- AUDIO SPEAKER
- SEE AV DRAWINGS FOR INFORMATION
- NOTE: SET SPEAKER INTO (BP2) CONCRETE. - PROVIDE AV BOX 5 5/8 x 16 7/8 x 13 3/16 - BP3 ADHESIVE
- 5/8" PLYWOOD
- RESILIENT UNDERLAYMENT
- VAPOR BARRIER
- NONCOMBUSTIBLE SLEEPERS ATTACHED WITH .145 DIA. P.D.F. AT 16" OC.
- 2" METAL BASE - VENTED
- CONDUIT AS REQUIRED - BP3
- BP2: STRUCTURAL SLAB

FLOOR DETAIL: METAL BASE AND STAGE EDGE @STAGE WOOD FLOOR 05

SCALE: 1.5" = 1'-0"



01

MOORE SCHOOL OF BUSINESS
UNIVERSITY OF SOUTH CAROLINA
BID PACKAGE 3
ENCLOSURE/SITE/MEPFP/INTERIOR
ADDENDUM #003
PROJECT NO. 655.000

^ ^
 2012.06.22
 © RAFAEL VINOLY ARCHITECTS PC

FLOORING DETAILS PERFORMANCE HALL
REF. DWG #A7404
SHEET TITLE :

SCALE :
1.5" = 1'-0"
SHEET NUMBER :
A-SK-097

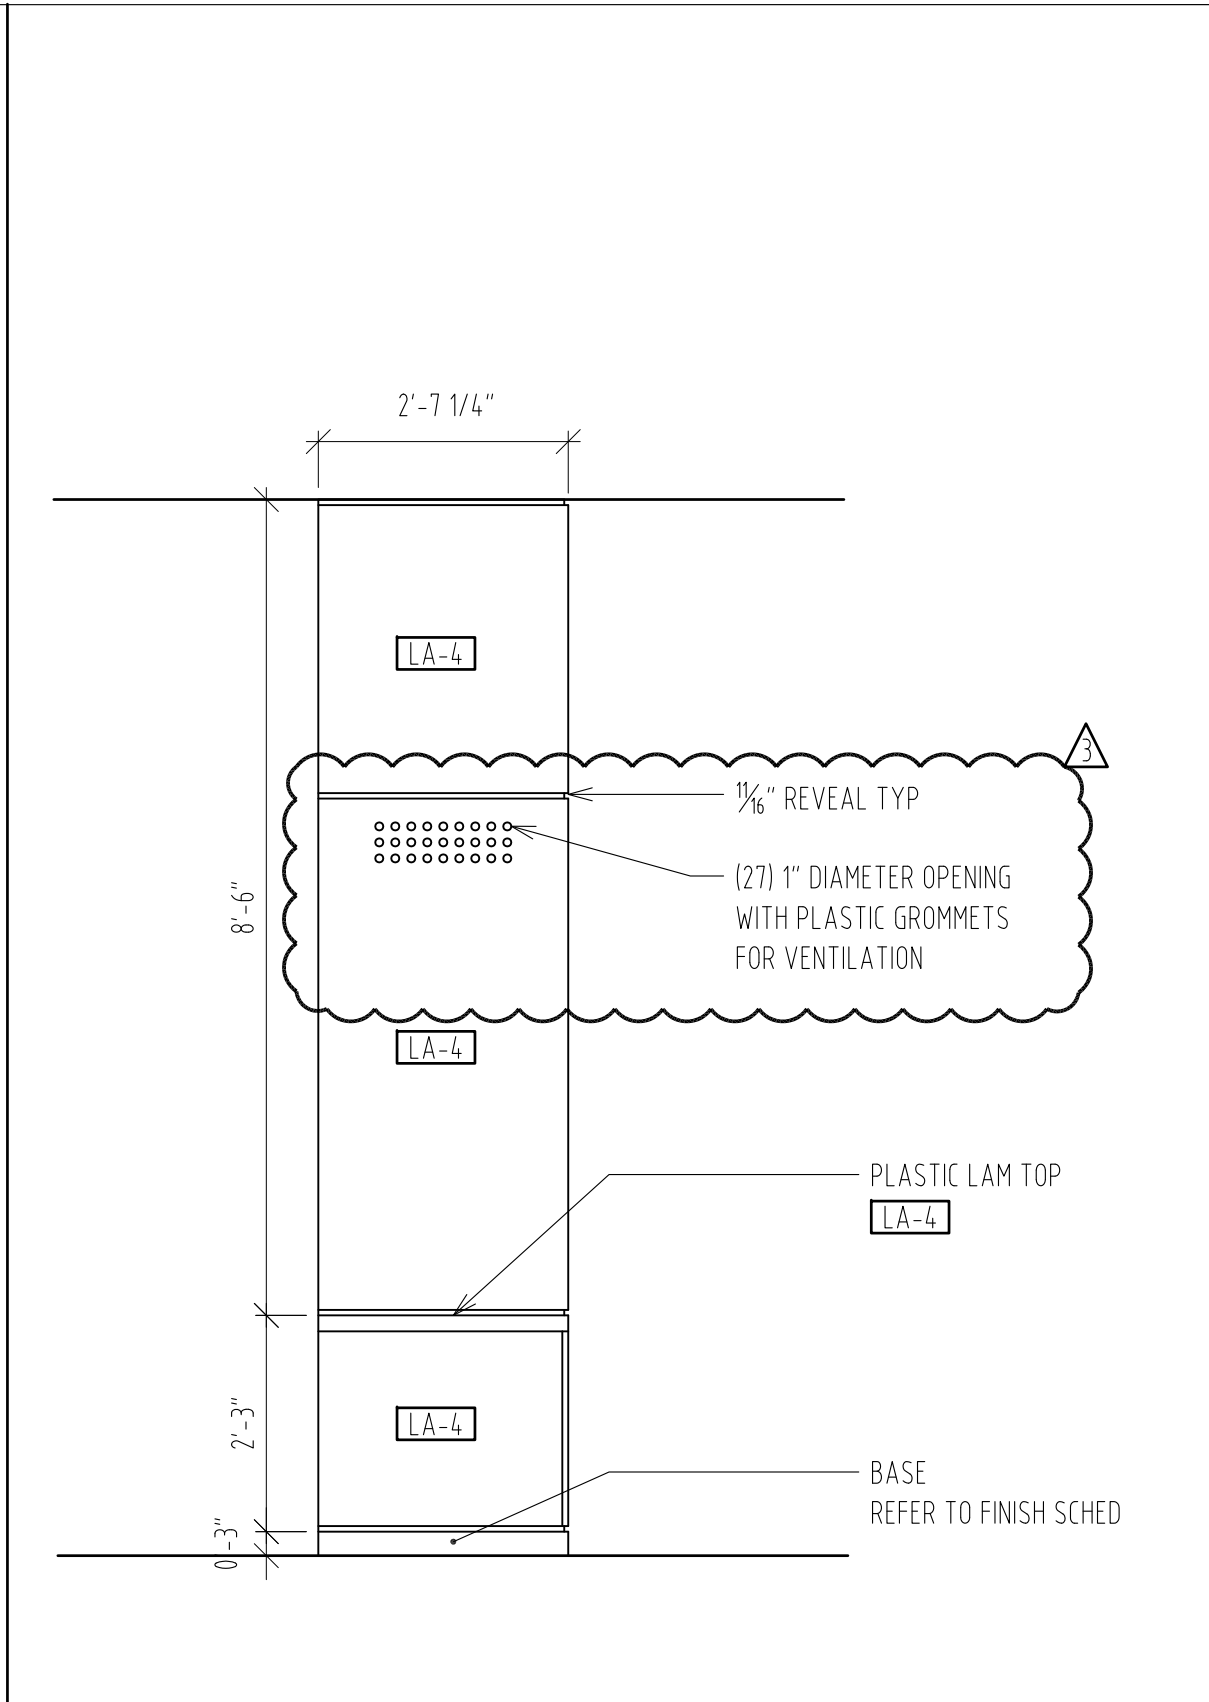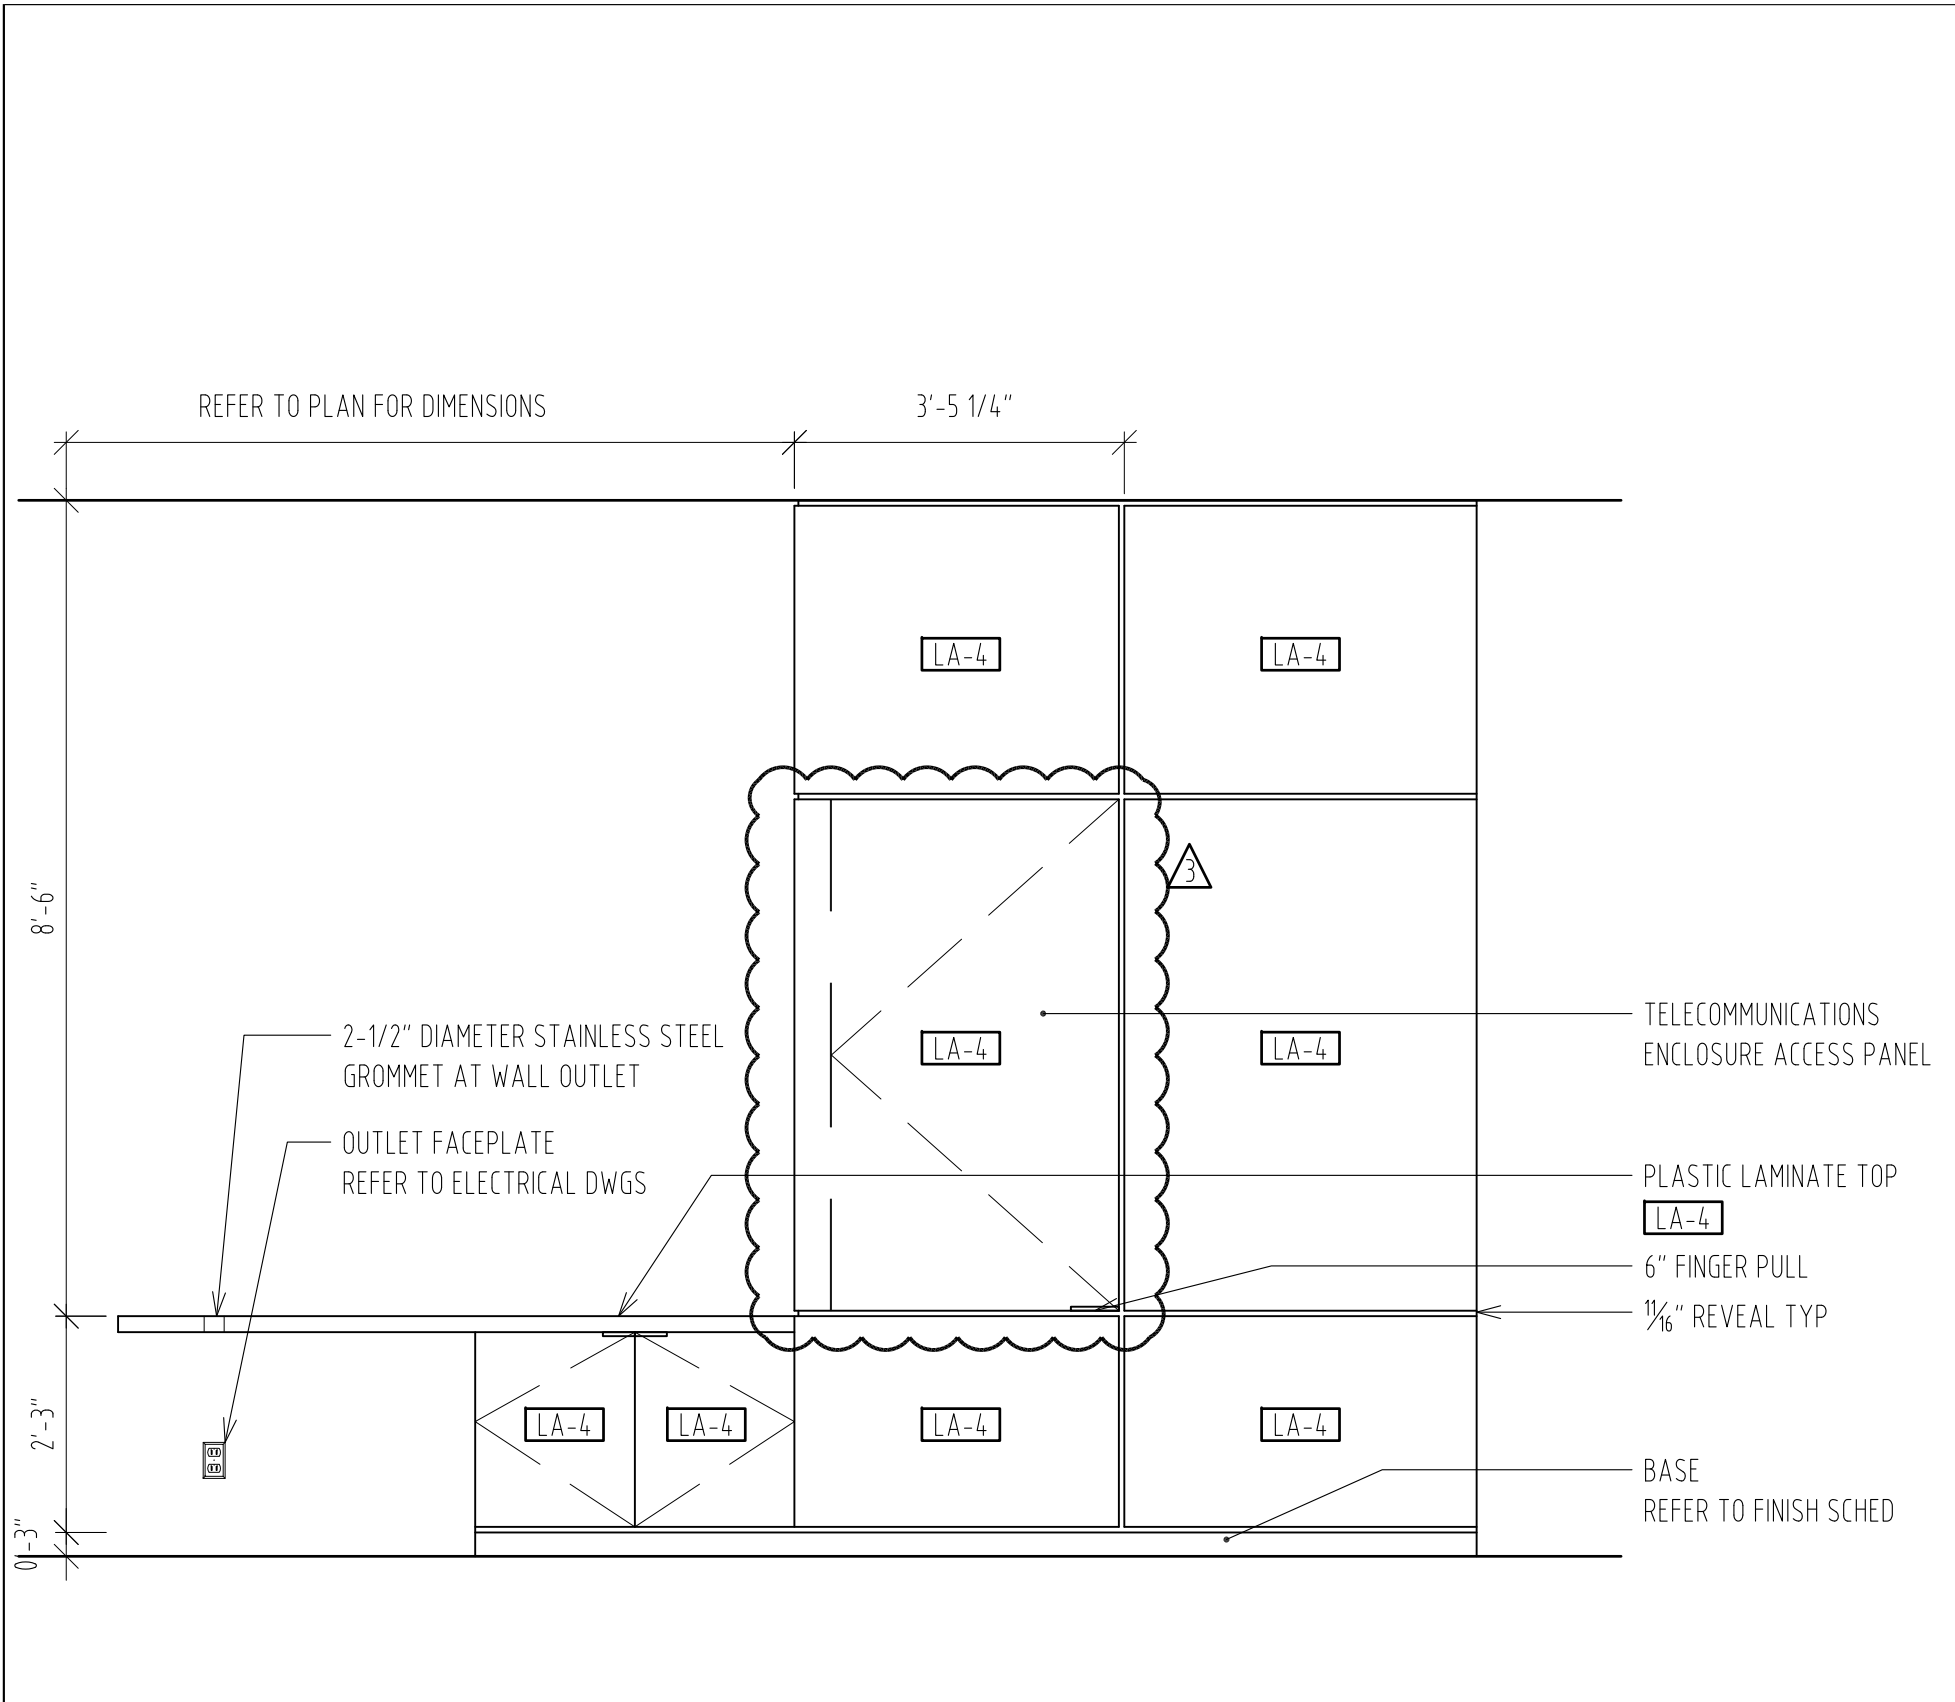

M-CR1-CREDENZA TYP. ELEVATION @ PROJECT ROOMS 08
 SCALE : 1/2" = 1'-0" 02


M-CR1-CREDENZA TYP. ELEVATION @ PROJECT ROOMS 07
 SCALE : 1/2" = 1'-0" 01

MOORE SCHOOL OF BUSINESS
 UNIVERSITY OF SOUTH CAROLINA
 BID PACKAGE 3
 ENCLOSURE/SITE/MEPFP/INTERIOR
 ADDENDUM #003
 PROJECT NO. 655.000

2012.06.22
 © RAFAEL VINOLY ARCHITECTS PC

MILLWORK PLANS & ELEVATIONS CREDENZAS & SHELVING
 REF. DWG #A7615
 SHEET TITLE :

SCALE :
 1/2" = 1'-0"
 SHEET NUMBER :
 A-SK-098

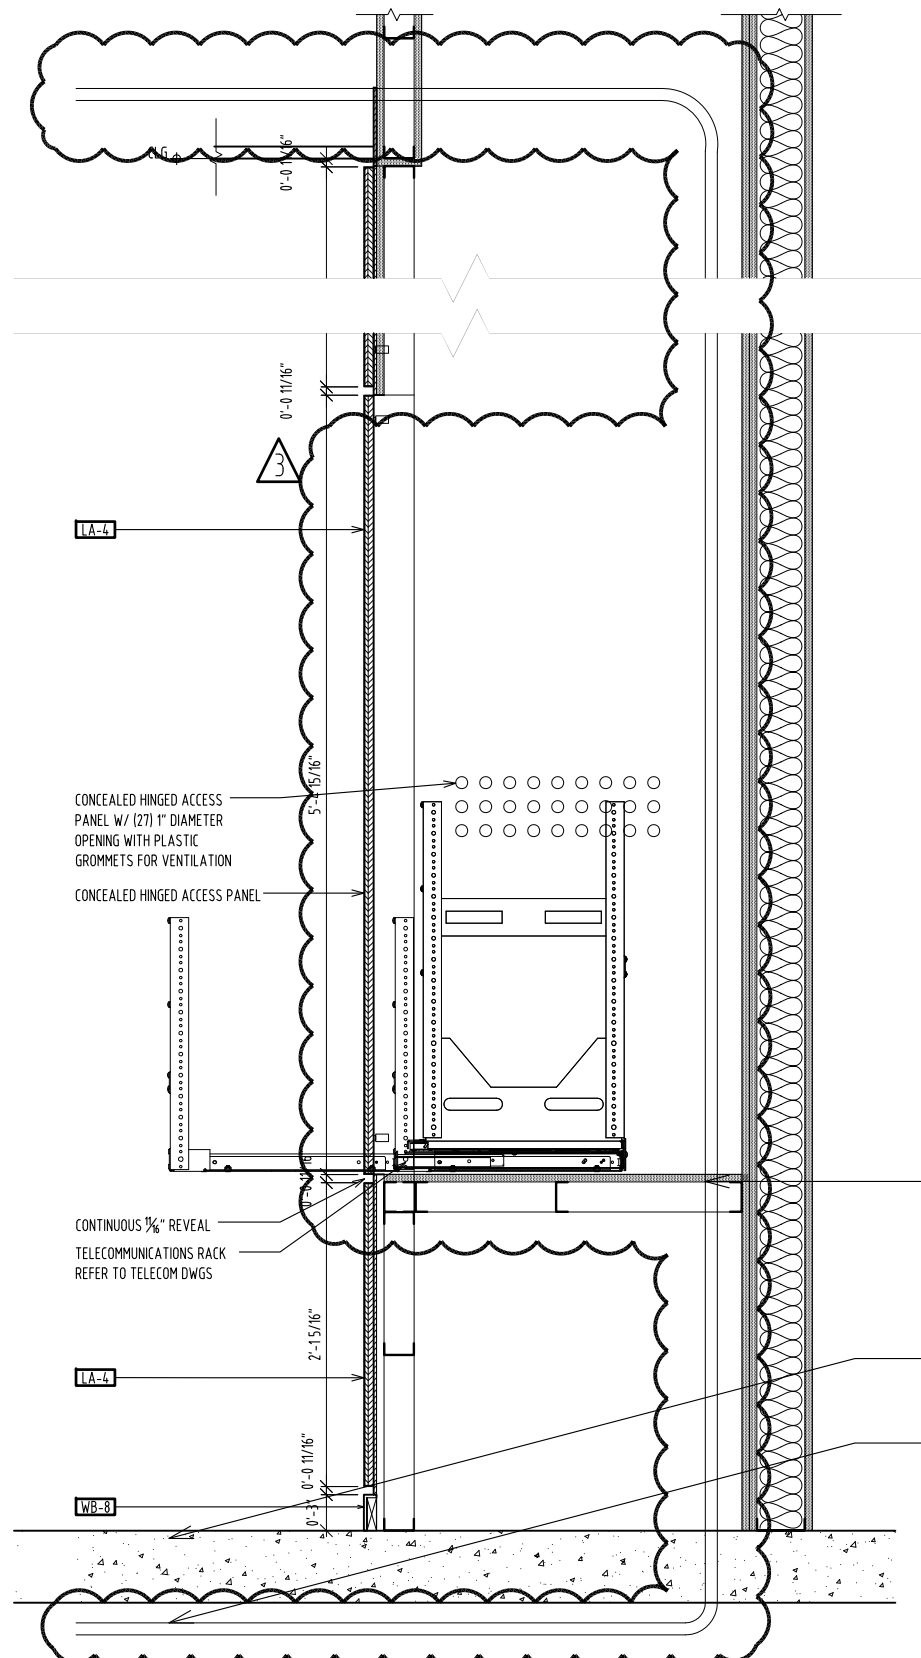

CONCEALED HINGED ACCESS
PANEL W/ (27) 1" DIAMETER
OPENING WITH PLASTIC
GROMMETS FOR VENTILATION
CONCEALED HINGED ACCESS PANEL

CONTINUOUS 3/8" REVEAL
TELECOMMUNICATIONS RACK
REFER TO TELECOM DWGS


PROVIDE REINFORCED SHELF FOR 350 LBS
EQUIPMENT (CONT. METAL BLOCKING
SHEET ON BOTTOM + 2 SIDES) - BP3

CONDUIT TO TELECOM ROOM - SEE T1201
ROUTING DRAWING - BP3

CONDUIT TERMINATES IN ACCESSIBLE
CEILING LOCATION

M-CR1 - CREDENZA SECTION DETAIL TYP. @ TELECOMMUNICATIONS ENCLOSURE
SCALE : 3/4" = 1'-0"

02

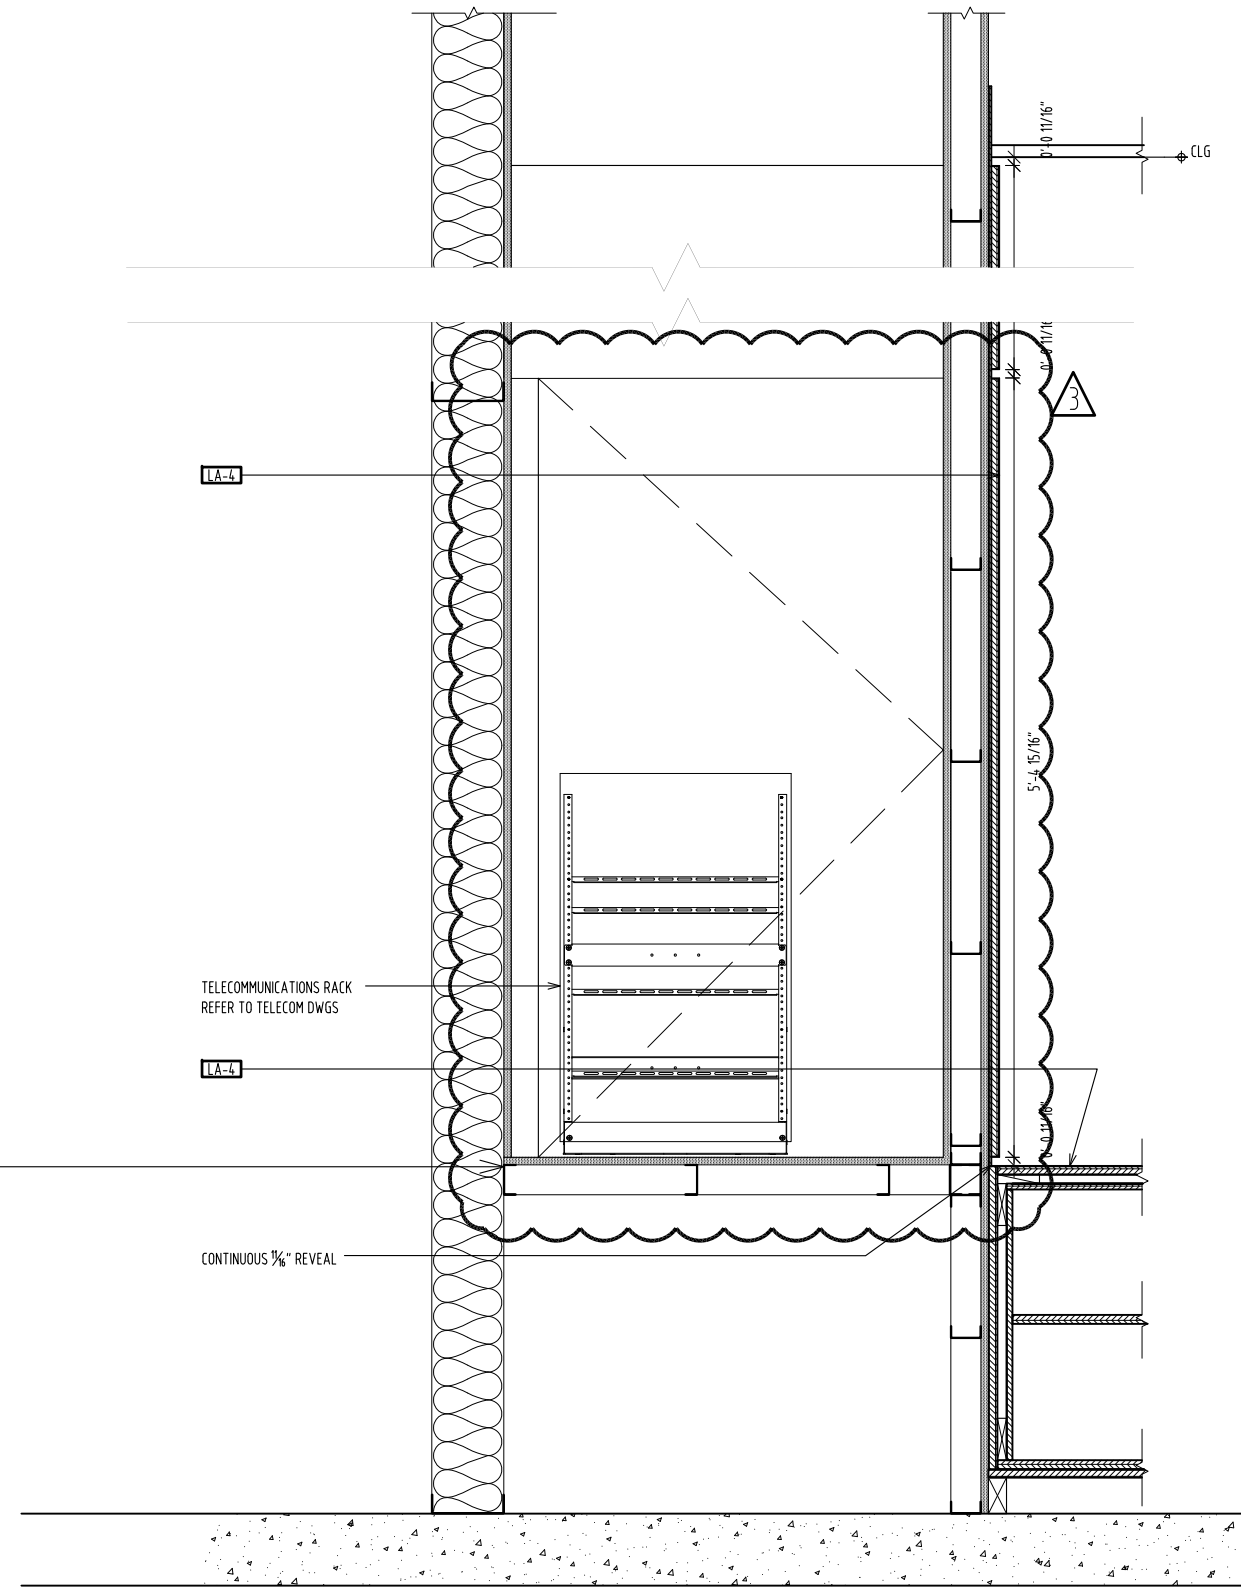


TELECOMMUNICATIONS RACK
REFER TO TELECOM DWGS

CONTINUOUS 3/8" REVEAL

M-CR1 - CREDENZA SECTION DETAIL TYP. @ TELECOMMUNICATIONS ENCLOSURE
SCALE : 3/4" = 1'-0"

01

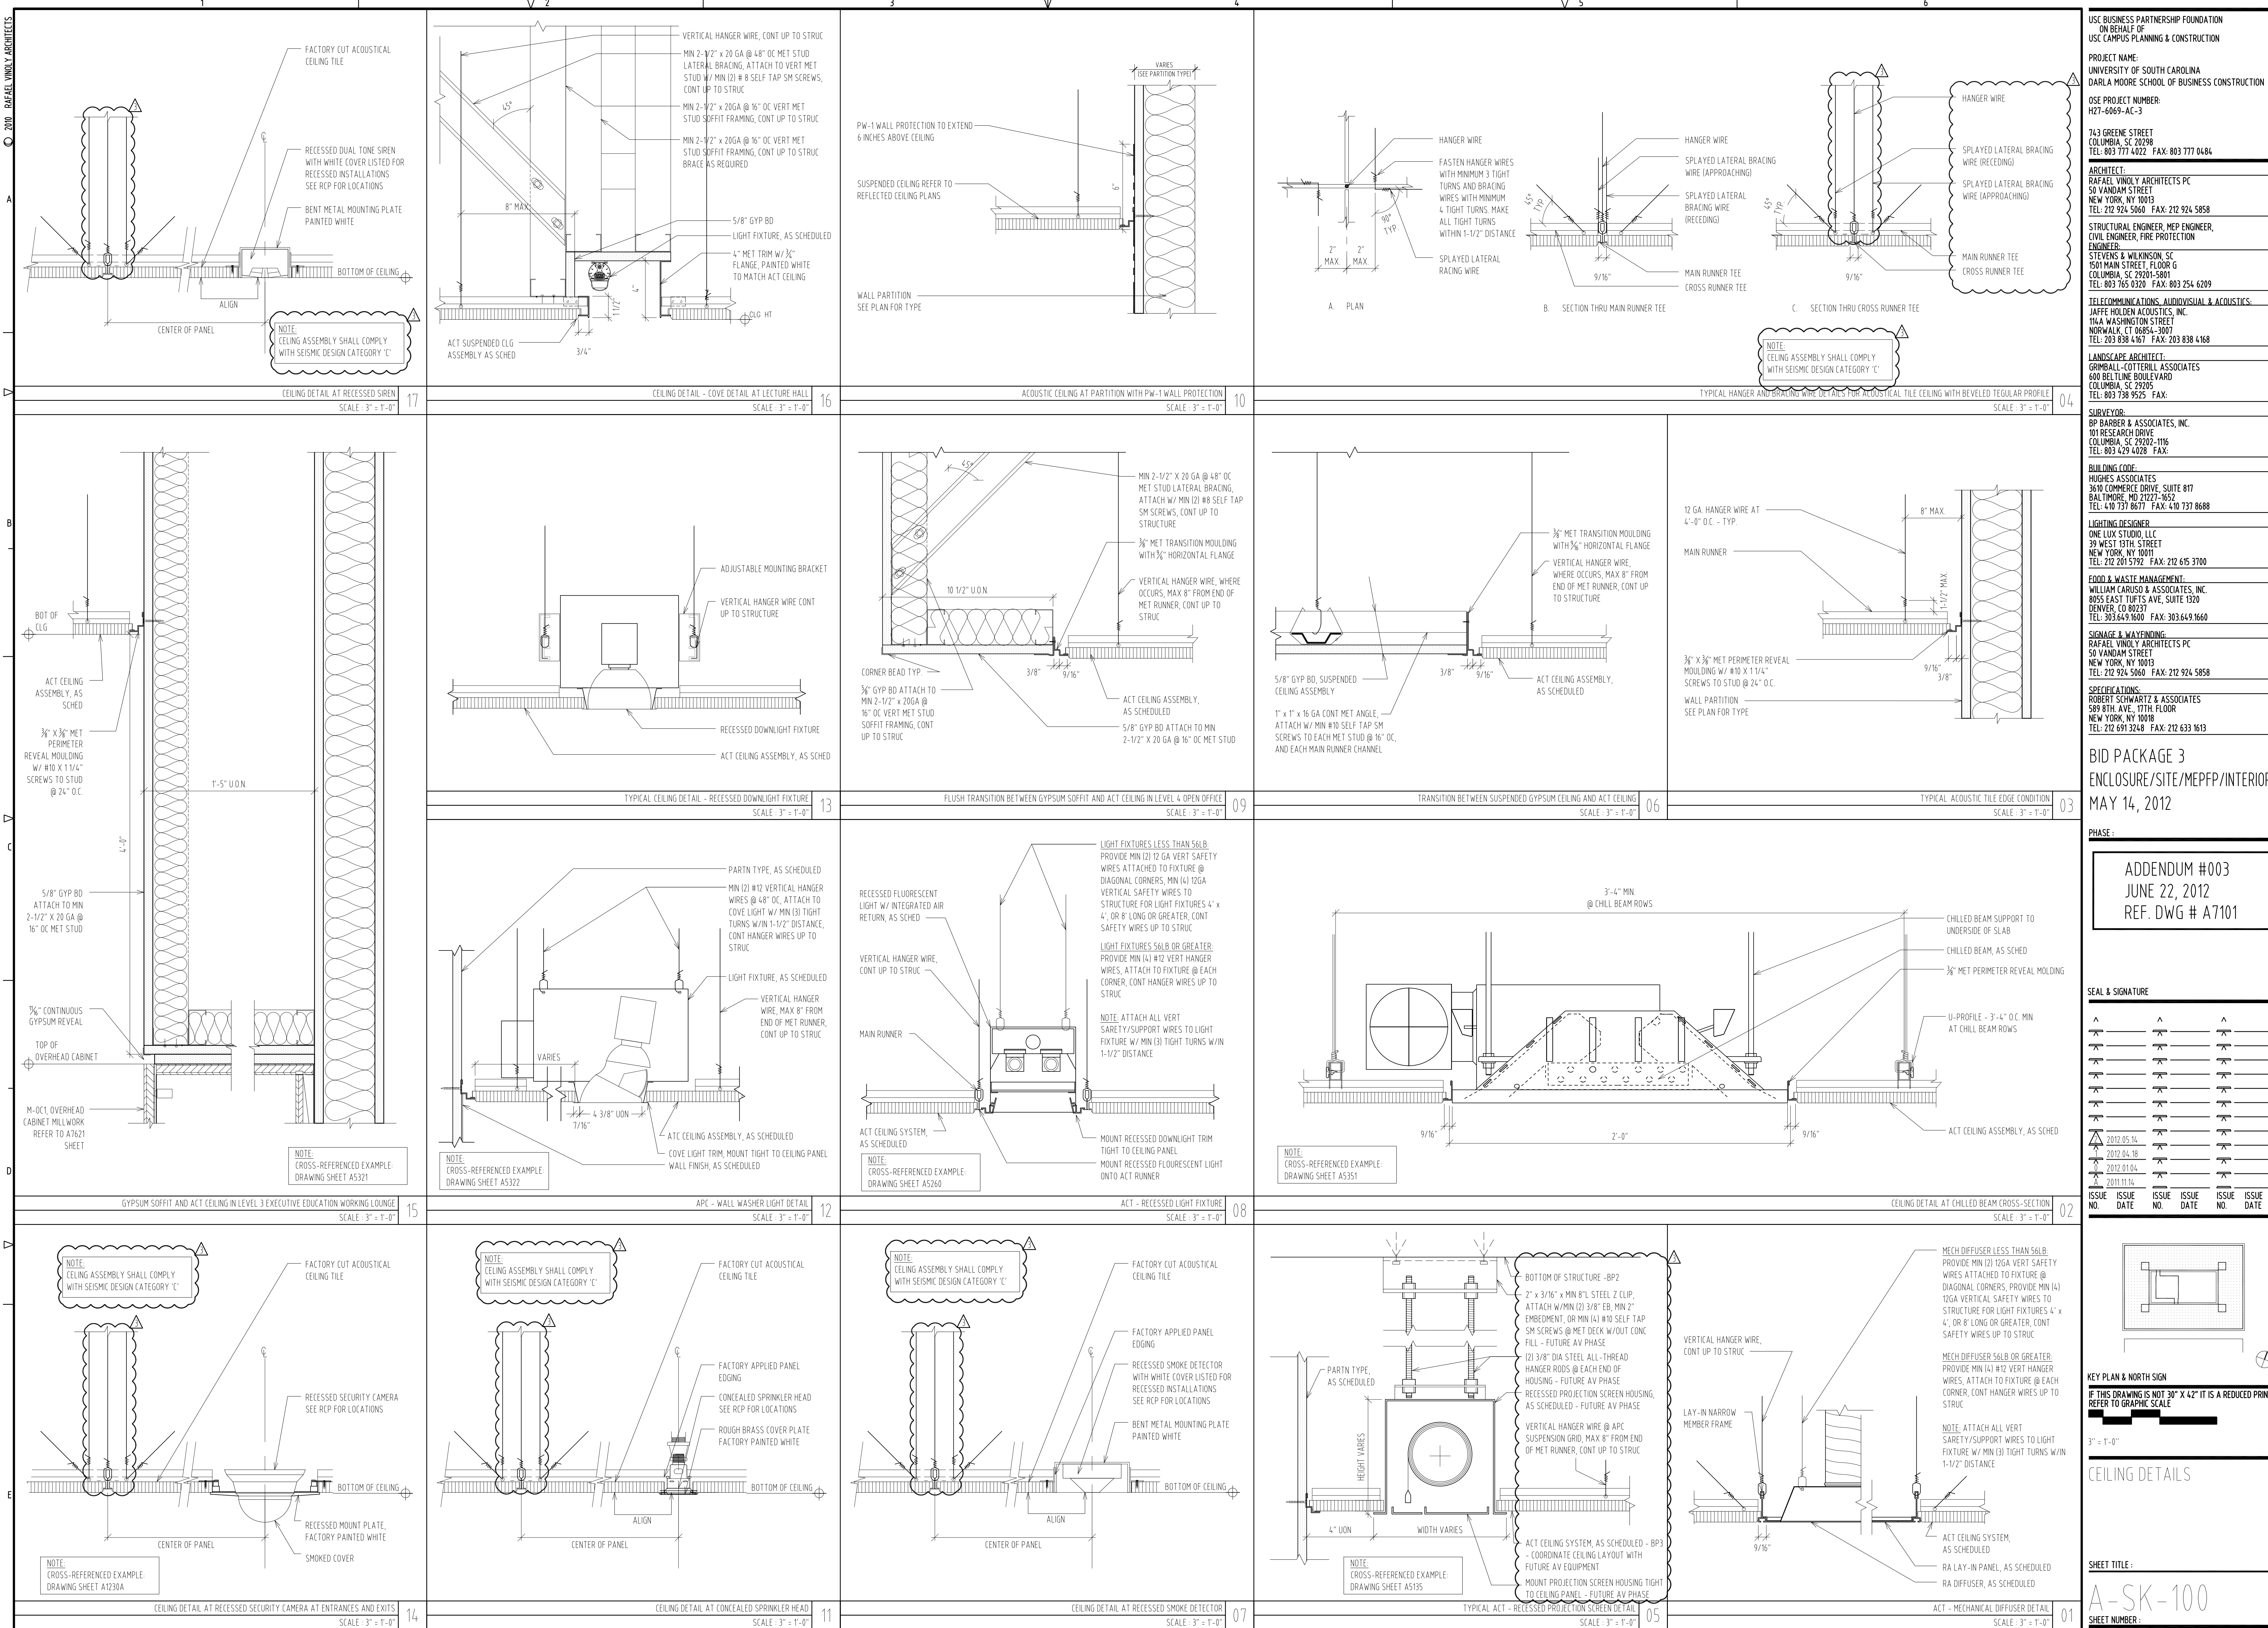

USC BUSINESS PARTNERSHIP FOUNDATION
ON BEHALF OF
USC CAMPUS PLANNING & CONSTRUCTION

PROJECT NAME:
UNIVERSITY OF SOUTH CAROLINA
DARLA MOORE SCHOOL OF BUSINESS CONSTRUCTION

OSE PROJECT NUMBER:
H27-6069-AC-3

743 GREENE STREET
COLUMBIA, SC 29298
TEL: 803 777 4022 FAX: 803 777 0484

ARCHITECT:
RAFAEL VINOLY ARCHITECTS PC
50 VANDAM STREET
NEW YORK, NY 10013
TEL: 212 924 5860 FAX: 212 924 5858

STRUCTURAL ENGINEER, MEP ENGINEER,
CIVIL ENGINEER, FIRE PROTECTION
ENGINEER:
STEVENS & WILKINSON, SC
1501 MAIN STREET, FLOOR 5C
COLUMBIA, SC 29201-5801
TEL: 803 765 0320 FAX: 803 254 6209

TELECOMMUNICATIONS, AUDIOVISUAL & ACoustICS:
JAFFE HOLDEN ACoustICS, INC.
114A WASHINGTON STREET
NORWALK, CT 06854-3007
TEL: 203 838 4167 FAX: 203 838 4168

LANDSCAPE ARCHITECT:
GRUMBALL-COTTELL ASSOCIATES
600 BELTLINE BOULEVARD
COLUMBIA, SC 29205
TEL: 803 738 9525 FAX:

SURVEYOR:
BP BARBER & ASSOCIATES, INC.
101 RESEARCH DRIVE
COLUMBIA, SC 29202-1116
TEL: 803 429 4028 FAX:

BUILDING CODE:
HUGHES ASSOCIATES
3610 COMMERCE DRIVE, SUITE 817
BALTIMORE, MD 21227-6652
TEL: 410 731 8677 FAX: 410 731 8688

LIGHTING DESIGNER:
ONE LUX STUDIO, LLC
39 WEST 19TH STREET
NEW YORK, NY 10011
TEL: 212 201 5792 FAX: 212 675 3700

FOOD & WASTE MANAGEMENT:
WILLIAM CARUSO & ASSOCIATES, INC.
8055 EAST TURTLE AVE, SUITE 1520
DENVER, CO 80237
TEL: 303 649 1600 FAX: 303 649 1660

SIGNAGE & WAYFINDING:
RAFAEL VINOLY ARCHITECTS PC
50 VANDAM STREET
NEW YORK, NY 10013
TEL: 212 924 5860 FAX: 212 924 5858

SPECIFICATIONS:
ROBERT SCHWARTZ & ASSOCIATES
589 8TH AVE., 17TH FLOOR
NEW YORK, NY 10018
TEL: 212 691 3248 FAX: 212 633 1613

BID PACKAGE 3
ENCLOSURE/SITE/MEFPF/INTERIOR
MAY 14, 2012

PHASE:

ADDENDUM #003
JUNE 22, 2012
REF. DWG # A7101

SEAL & SIGNATURE

ISSUE NO.	ISSUE DATE	ISSUE NO.	ISSUE DATE	ISSUE NO.	ISSUE DATE
1	2012.05.14	2	2012.04.18	3	2012.01.04
4	2011.11.14				

KEY PLAN & NORTH SIGN
IF THIS DRAWING IS NOT 30" X 42" IT IS A REDUCED PRINT.
REFER TO GRAPHIC SCALE

3" = 1'-0"

CEILING DETAILS

SHEET TITLE:
A-SK-100

SHEET NUMBER: